

# CENTRAL WEST

579 W 200 S  
Salt Lake City, Utah



PROJECT TEAM			
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Civil Engineer : <b>Ensign Engineering</b> CONTACT : Jared Ford PHONE (801) 255-0529		Landscape Architect : <b>STB Design</b> CONTACT : Scott Blake PHONE (801) 554-6146	
Structural Engineer : <b>Canyons Structural Consulting</b> CONTACT : Dany Tremblay PHONE (801) 486-6848		Interior Designer : <b>Architecture Belgique, Inc.</b> CONTACT : Heather Cardall PHONE (801) 561-1333	

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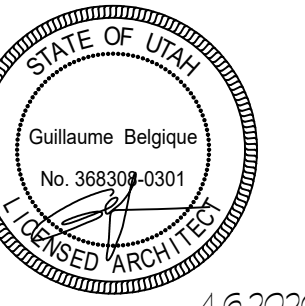
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4.6.2020

**CENTRAL WEST**  
579 WEST 200 SOUTH  
SALT LAKE CITY, UT

Date

DATE REVISIONS


Sheet Title

Cover Sheet


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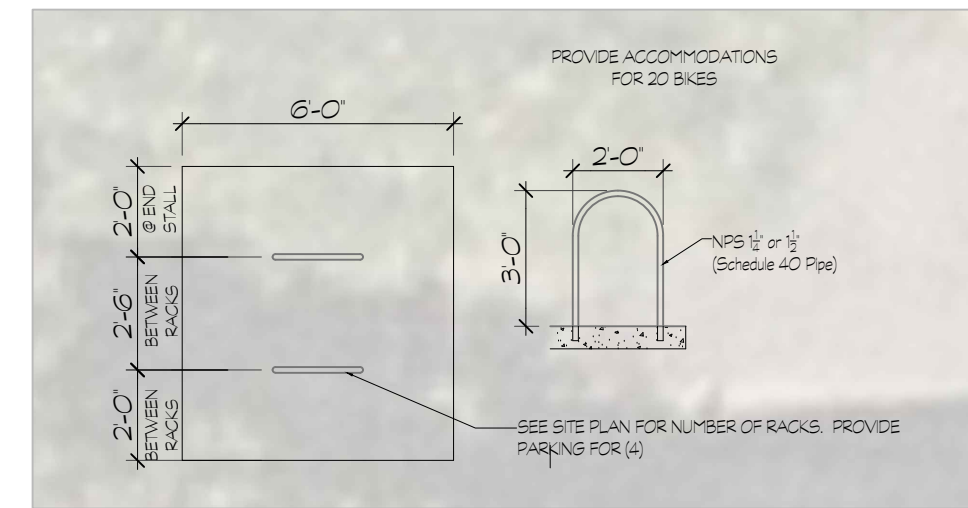


**1 ARCHITECTURAL SITE PLAN**  
 AO.01 SCALE: 3/32 = 1'-0"  
 (24' x 36')

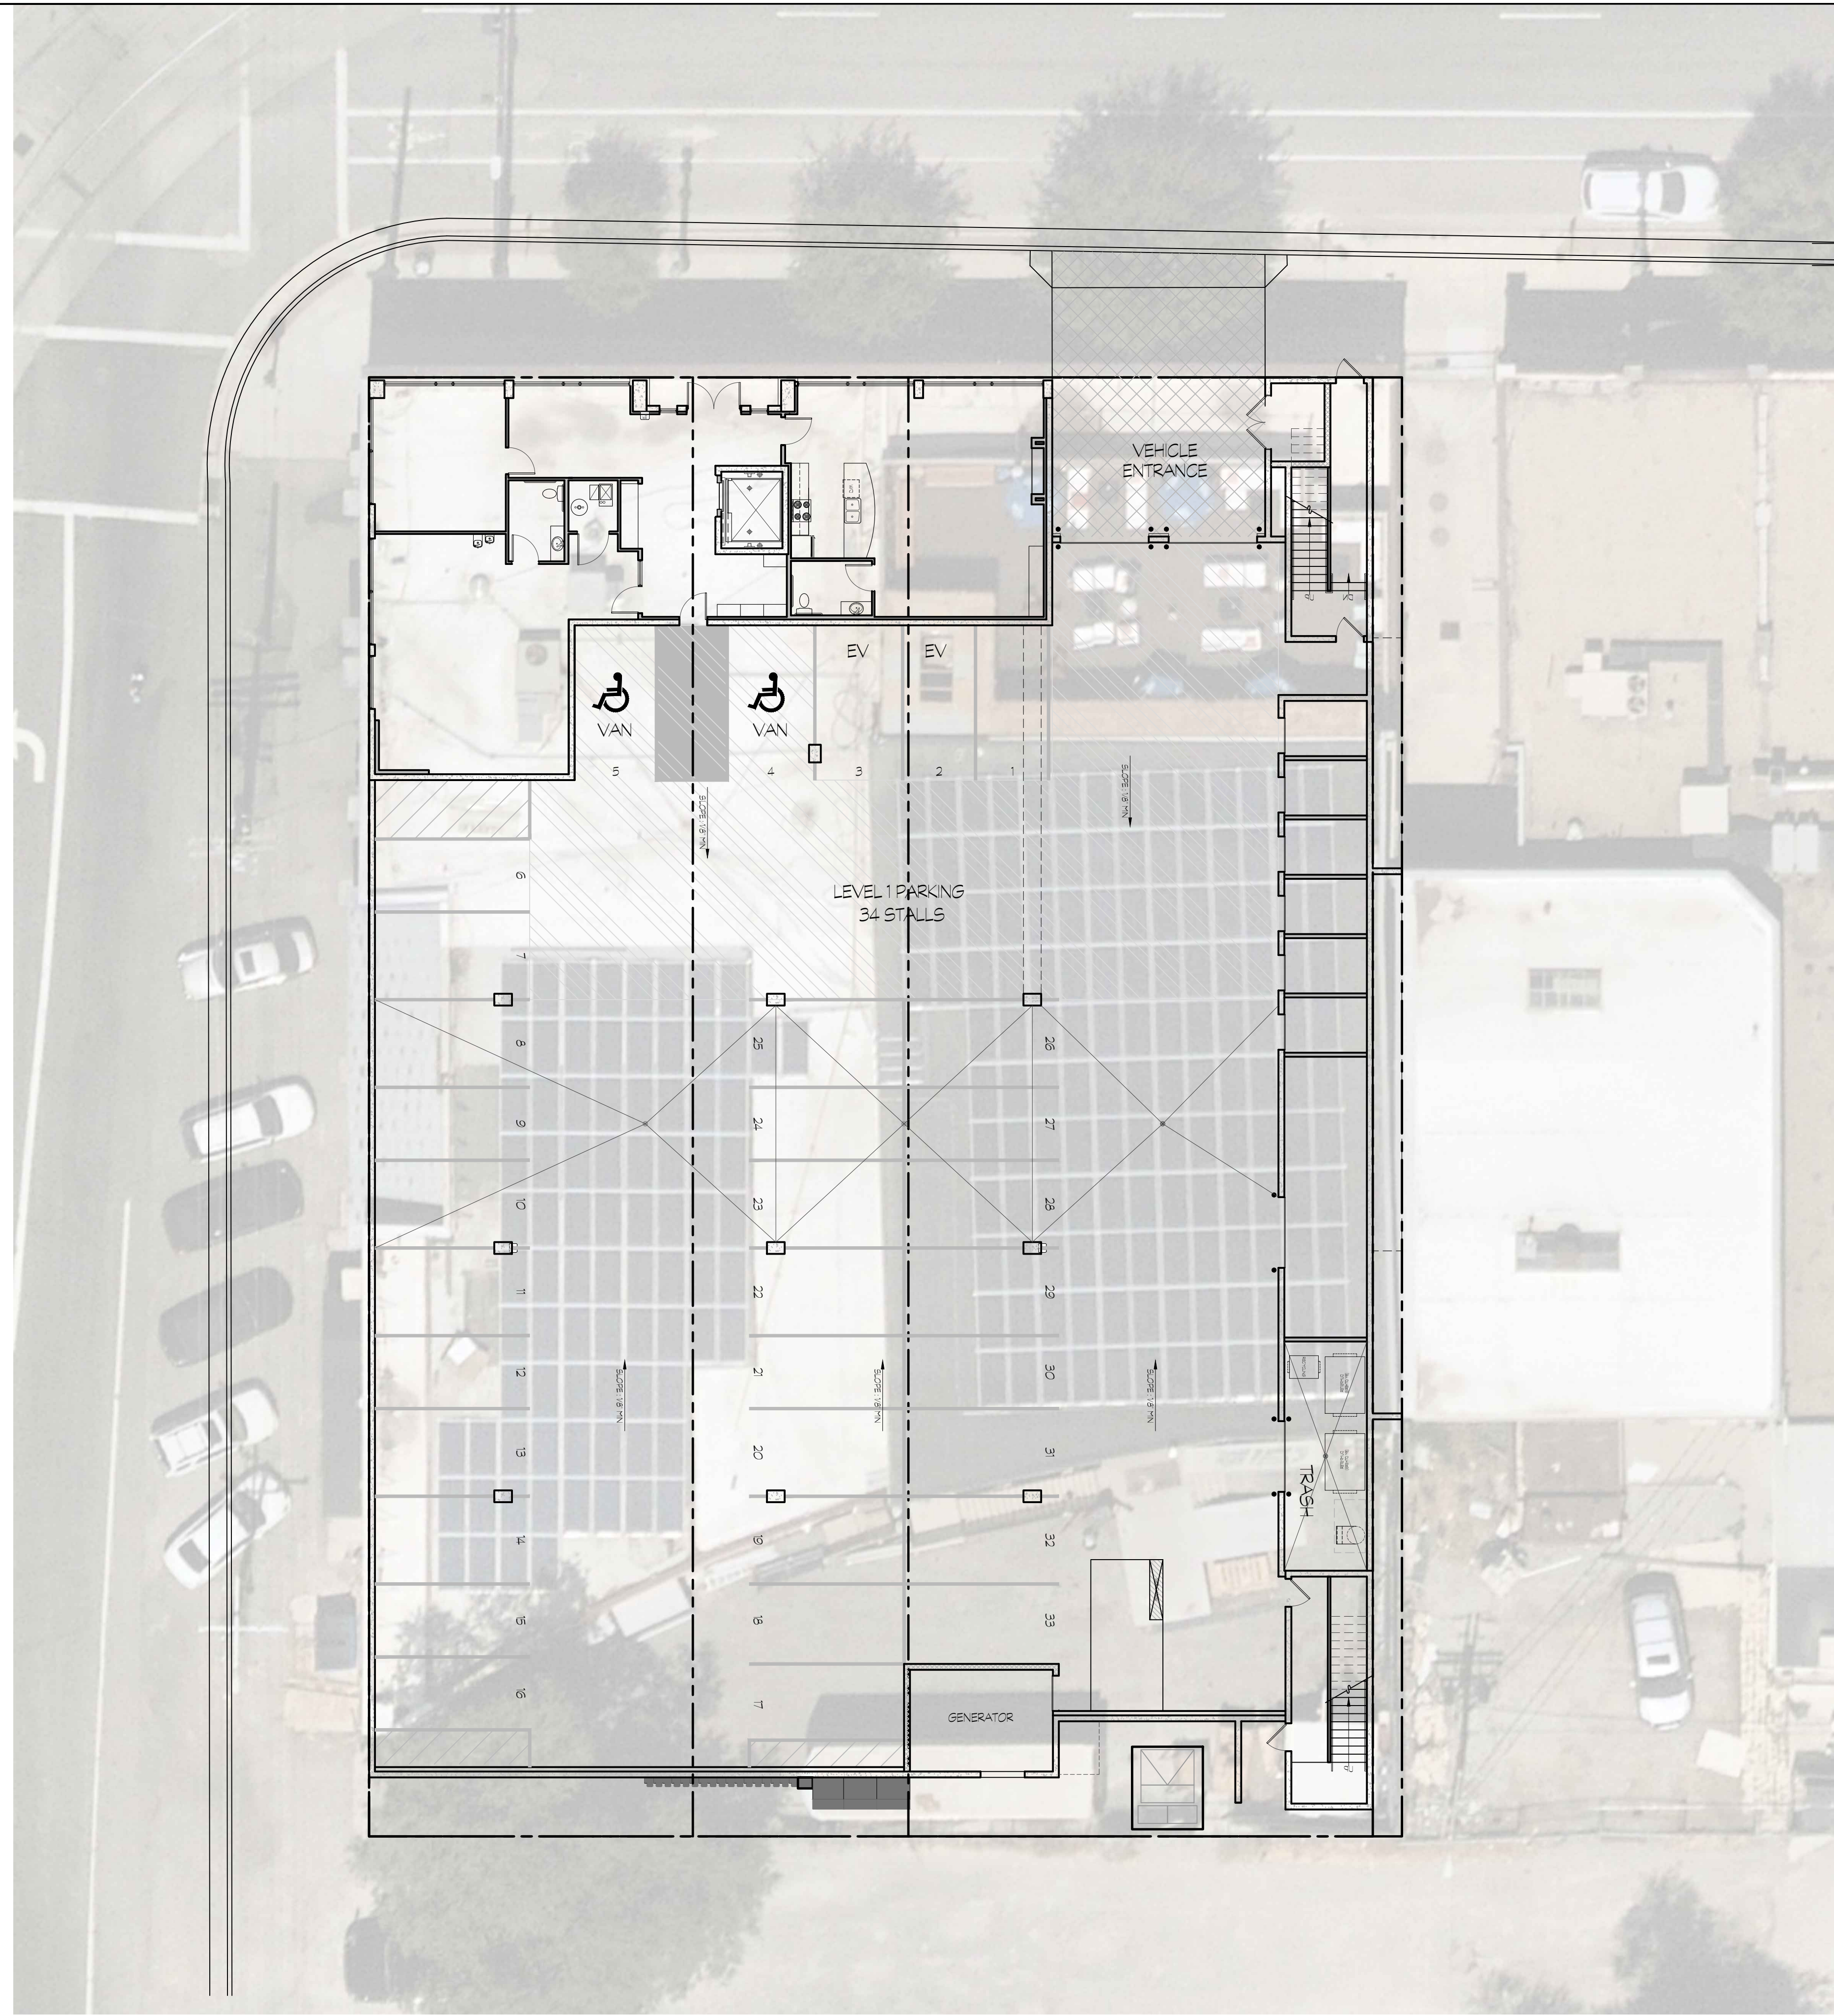

SITE TABULATION			
TOTAL :	19,272sqft	.44Acres	100%
Building :	17,491sqft	.4Acres	91%
Site Open space :	1,781sqft	.4Acres	9%


PARKING CALCULATIONS	
GMU Req'd parking: .5 space/dwelling unit	
Total Units: 65x.5 = 32.5 req'd stalls	
Total parking provided:	34 stalls
Including:	
Accessible stalls:	2 stalls
Electric vehicle stalls:	2 stalls
Req'd bicycle parking: 5% of vehicular parking provided	
Total provided parking:	34 vehicular stalls
34 x 5% = 1.7 (2) req'd stalls	

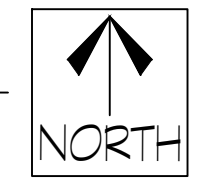

**2 BIKE PARKING RACK DETAIL**  
 AO.01 SCALE: 3/32 = 1'-0"  
 (24' x 36')



**3 VICINITY MAP**  
 AO.01 SCALE: NTS  
 (24' x 36')

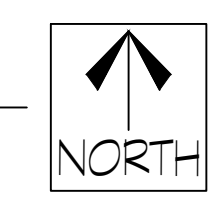

ARCHITECTURAL SITE PLAN IS FOR REFERENCE ONLY. REFER TO CIVIL & LANDSCAPE DRAWINGS FOR ALL SITE DIMENSIONS, GRADING, DETAILS & ACCESSIBILITY INFORMATION.

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STATE OF UTAH  
 Guillaume Belgique  
 No. 368309-0301  
 LICENSED ARCHITECT  
 4.6.2020

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 SALT LAKE CITY, UT

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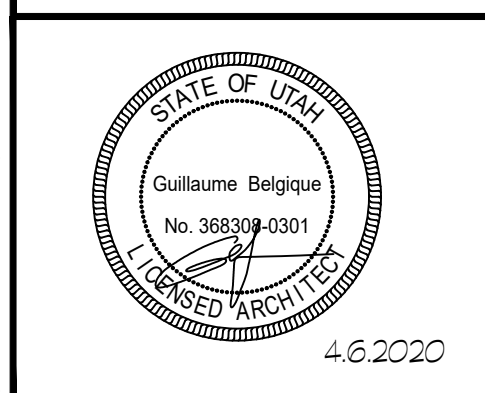
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**Sheet Title**  
 Architectural Site Plan

**Sheet Number**  
 AO.01

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**CENTRAL WEST**  
579 WEST 200 SOUTH  
SALT LAKE CITY, UT

**Date**

DATE	REVISIONS

**Sheet Title**

Overall Floor Plan Level 1

**Sheet Number**


A1.01

**OVERALL FLOOR PLAN KEYED NOTES:**


- SCHEDULED DOOR. SEE DOOR SCHEDULE, TYPES AND STYLES ON SHEET A8.01. PROVIDE AND INSTALL ALL REQUIRED DOOR FLASHING PER MANUFACTURER'S RECOMMENDATIONS.
- SCHEDULED WINDOW. SEE WINDOW SCHEDULE, TYPES AND STYLES ON SHEET A8.02. PROVIDE AND INSTALL ALL REQUIRED FLASHING PER MANUFACTURER'S RECOMMENDATIONS.
- TACTILE SIGN STATING "EXIT" AND COMPLYING WITH ICC A117.1 IS TO BE PROVIDED ADJACENT TO EACH DOOR TO AN EGRESS STAIRWAY (BC SECTION 101.3).
- FLOOR LEVEL IDENTIFICATION SIGNS IN TACTILE CHARACTERS COMPLYING WITH ICC A117.1 SHALL BE LOCATED AT EACH FLOOR LEVEL LANDING ADJACENT TO THE DOOR LEADING TO THE CORRIDOR. SEE DETAIL 3/D1.01. IBC 1022.8.1
- G.C. TO PROVIDE TACTILE EXIT SIGNS WHICH READ "IN CASE OF FIRE, ELEVATORS ARE OUT OF SERVICE. USE STAIRS" IN COMPLIANCE WITH SECTION 3002.3 OF THE IBC.
- SCHINDLER 3300 XL MACHINE ROOM-LESS PASSENGER ELEVATOR (3500 & 4000 LB CAPACITY AND 200PM SPEED) WITH STAINLESS STEEL DOOR AND CAB (8'-0" TALL) INSTALLED BY ELEVATOR MANUFACTURER. COORDINATE WITH MANUFACTURER ELECTRICAL, MECHANICAL AND HOIST REQUIREMENTS. SEE ELECTRICAL AND MECHANICAL DRAWINGS. ELEVATOR CAR SHALL ACCOMMODATE A 24-INCH BY 64-INCH AMBULANCE STRETCHER IN THE HORIZONTAL OPEN POSITION AND SHALL BE IDENTIFIED BY THE INTERNATIONAL SYMBOL FOR EMERGENCY MEDICAL SERVICES (STAR OF LIFE) THE SYMBOL SHALL NOT BE LESS THAN 3-INCHES HIGH AND SHALL BE PLACED INSIDE ON BOTH SIDES OF THE HOISTWAY DOOR FRAME. IBC SECTION 3002.4
- FOUNDATION WALLS AT ELEVATOR PIT PER STRUCTURAL DRAWINGS. SEE DETAIL 12/D1.02 FOR CONTINUOUS WATERPROOFING AT EXTERIOR FACE BELOW GRADE. LOCATE BUCKET IN CORNER OF PIT FOR FUTURE SLUMP PUMP.
- FIRE EXTINGUISHER CABINET. SEE DETAIL 1/D1.01
- VERIFY OPENING SIZE AND DETAILS WITH TRASH CHUTE MANUFACTURER. TRASH CHUTE OPENINGS TO BE PROTECTED WITH 90 MIN FIRE RATED SELF-CLOSING DOORS AND BE FIRE SPRINKLED PER BC 903.2/1.2. TRASH CHUTE TO BE PROVIDED WITH SANITIZING SYSTEM.
- 6" CONCRETE FILLED STEEL PIPE BOLLARDS MIN 3'-0" HIGH AND 3'-0" DEEP IN CONCRETE FOOTING (SURFACE MOUNTED WHEN IN PIT DECK)
- HIGH SPEED ALBANY GARAGE DOOR. PROVIDE 5 GARAGE DOOR OPENERS. GARAGE DOOR TO BE OPENED BY BA (BARCODE AUTOMATION INC.) DUAL BEAM DECAL SCANNER. BA-440 OR APPROVED EQUAL. PROVIDE MIN 150 TOTAL STOCKERS THAT ARE BLACK ON BLACK. EXITING GARAGE TO BE CONTROLLED BY MOTION SENSOR.
- CONCRETE COLUMNS TO HAVE SMOOTH ARCHITECTURAL FINISH WITH CHAMFERED CORNERS.
- A VERTICAL CLEARANCE OF 126" AT HATCHED AREA AROUND LOADING BERTH (INDICATED WITH GRAY SHADING)
- PROVIDE SIGNAGE PER BC 111 AND SECTION 502.7 OF ICC A117.09 FOR ACCESSIBLE PARKING A MINIMUM OF 60' ABOVE THE SURFACE OF PARKING. VAN ACCESSIBLE PARKING SHALL BE MARKED AS VAN ACCESSIBLE. SEE DETAIL 8/D1.01
- CONDENSING UNIT ON WALL MOUNTED HANGAR.
- CONCRETE FOUNDATION WALL WITH SMOOTH ARCHITECTURAL FINISH ABOVE GRADE. SEE STRUCTURAL DRAWINGS. REVEAL PER DETAIL 10/D1.02
- STEEL STUD FRAMING WITH DENSGLASS SHEATHING AT ALL LEVEL 1 LOCATIONS. SEE STRUCTURAL FOR GAUGE AND SPACING.
- SEE CIVIL AND LANDSCAPE DRAWINGS FOR CONTINUATION OF SIDEWALK. MAXIMUM 2% SLOPE AT EXTERIOR DOOR LANDINGS IN THE DIRECTION OF TRAVEL.
- ELECTRICAL METER LOCATION. COORDINATE WITH ELECTRICAL DRAWINGS.
- GAS METER LOCATION. COORDINATE WITH PLUMBING DRAWINGS.
- VERIFY MAIL ROOM REQUIREMENTS WITH US POST OFFICE FOR EXACT CONFIGURATION AND NUMBER OF BOXES. SEE DETAIL 1/D1.02
- COURTYARD FINISHED PER LANDSCAPE DRAWINGS
- PIT DECK TO STEP IN COURTYARD. SEE DETAILS 6-B/D1.07 AND STRUCTURAL DRAWINGS
- PAINTED GYP BOARD WALL FINISH. PAINT COLOR AND BRAND TO BE OWNER SELECTED. SEE OWNERS SPEC AND INTERIOR DESIGN DRAWINGS.
- EXTERIOR 2 HOUR RATED ASSEMBLY. SEE STRUCTURAL DRAWINGS. SEE DETAIL 2/P1.01
- TENANT DEMISING WALLS. SEE SHEETS P1.03-P1.09. SEE DETAIL 5-B/P1.01
- PRE-MANUFACTURED POWDER COATED STEEL DECK GUARDRAIL (42" HIGH) PER CODE (TYP). SEE DETAIL 3/D1.04
- ALL WALLS SEPARATING CONDITIONED FROM UNCONDITIONED SPACE PROVIDE 1/2" AIR GAP BETWEEN FRAMING AND CONCRETE. INSULATE & MAINTAIN GAP. PROVIDE VAPOR BARRIER ON INTERIOR SIDE.
- 6 GAO FLUID APPLIED DECK MEMBRANE AT UNIT BALCONIES, PATIOS OVER PT DECK AND COURTYARD OVER PT DECK. INSTALL PER MANUFACTURER'S RECOMMENDATIONS. SEE DETAILS 12/D1.04.
- UNIT BALCONIES AND PATIOS OVER PT DECK SLOPED MIN 1/4" PER FOOT FOR DRAINAGE. SEE PLUMBING DRAWINGS FOR LOCATIONS AND PIPING OF UNIT BALCONY DRAINS.
- CRICKETS AS NECESSARY FOR PROPER ROOF DRAINAGE.
- CLASS B SINGLE PLY ENERGY STAR COMPLIANT TPO ROOF MEMBRANE (60 ML WITH 20 YEAR WARRANTY OVER SCHEDULED SHEATHING AND BOX TRUSSES). SLOPE TOWARDS ROOF DRAINS. SEE STRUCTURAL AND PLUMBING DRAWINGS AND DETAIL 1/P1.02. SEE DETAILS 3-4/D1.08 FOR PIPE PENETRATIONS
- ROOF DRAINS. PRIMARY ROOF DRAIN SHALL CONNECT TO STORM SEWER. SECONDARY DRAIN SHALL DAYLIGHT THROUGH BUILDING WALL AT MAIN FLOOR LEVEL WITH STANDARD BRASS FITTING. SEE PLUMBING DRAWINGS. SEE DETAILS 12/D1.08
- CONDENSING UNIT ON RUBBER PAD ON WOOD FRAMED PLATFORM. SLOPE PLATFORM FOR DRAINAGE ONTO ROOF. SEE MECHANICAL AND PLUMBING DRAWINGS. SEE STRUCTURAL DRAWINGS FOR FRAMING DETAIL.
- RUBBER ROOFTOP TRAFFIC PAD SYSTEM INSTALLED PER MANUFACTURER'S RECOMMENDATIONS.
- ROOF PARAPET. SEE PARAPET ROOF DETAILS 9-1/D1.01. SEE STRUCTURAL DRAWINGS FOR ASSOCIATED LATERAL BRACINGS AND DETAILS (TYP.)
- VERIFY HEIGHT OF ELEVATOR SHAFT OVERRUN WITH ELEVATOR MANUFACTURER
- SLOPE ELEVATOR AND STAR TOWER ROOFS TO DRAIN TO GUTTER AND DOWNSPOUT ONTO SPLASH BLOCK AT LOWER ROOF
- MECHANICAL SHAFT ROOF PENETRATION. SEE DETAIL 3/D1.08
- MECHANICAL SHAFT ROOF OVERBUILD
- 6'-0" TALL DECORATIVE FENCE SEE DETAIL 9/D1.02

**GENERAL NOTES:**


- ALL BATHROOMS SHALL BE ADAPTABLE. GENERAL CONTRACTOR SHALL VERIFY THAT ALL FIXTURE LOCATIONS, SOLID BLOCKING AND CLEAR FLOOR SPACES SHALL MEET THE MINIMUM REQUIREMENTS OF THE 2015 IBC, ANS I117.1.03 AND THE REQUIREMENTS OF SPECIFICATION A BATHROOM OF THE FAIR HOUSING ACT DESIGN MANUAL.
- ALL ENTRANCES TO UNITS SHALL BE ON AN ACCESSIBLE ROUTE AND PROVIDE DISABLED ACCESS TO THE UNITS. FLOOR LEVEL OUTSIDE DOORWAYS SHALL BE NO MORE THAN 1/2" BELOW INSIDE FLOOR LEVEL AND SHALL NOT SLOPE MORE THAN 1/8" PER FOOT.
- ALL ENTRY DOORS SHALL BE 36" WIDE. HAVE LEVER TYPE LATCHES AND HAVE THRESHOLDS NO HIGHER THAN 1/2" WHICH ARE BEVELED WITH A SLOPE NO GREATER THAN 1/2". SEE DETAIL 3/D1.01
- CLEAR WIDTH OF AN ACCESSIBLE ROUTE SHALL BE 36" MINIMUM, EXCEPT AT DOORS. CLEAR WIDTH OF THE ACCESSIBLE ROUTE WITH TURNS AROUND AN OBSTRUCTION LESS THAN 48" WIDE SHALL HAVE A CLEAR SPACE OF 42" x 48".
- ELECTRICAL SWITCHES, OUTLETS, THERMOSTATS AND OTHER ENVIRONMENTAL CONTROLS SHALL HAVE NO OPERABLE PARTS WHICH ARE HIGHER THAN 48" NOR LESS THAN 15" A.F.F.
- ALL UNITS ARE TO BE PROVIDED WITH SOLID BLOCKING BETWEEN STUDS IN THE BATHROOM WALLS BEHIND THE TOILET AND AROUND THE TUB AND BETWEEN THE WALL & THE BACK SURFACE OF THE TUB SHOWER SPLASH FOR THE POSSIBLE FUTURE INSTALLATION OF GRAB BARS. (POSSIBLE FUTURE GRAB BAR AT THE SIDE OF THE TOILET WOULD BE EITHER A WALL-TO-FLOOR TYPE OR FOLD-DOWN TYPE). SEE ENLARGED BATHROOM PLANS.
- A CLEAR FLOOR SPACE AT LEAST 30" x 48" THAT ALLOWS EITHER A FORWARD OR A PARALLEL APPROACH BY A PERSON IN A WHEELCHAIR SHALL BE PROVIDED AT ALL APPLIANCES IN THE KITCHEN INCLUDING THE RANGE COOKTOP, OVEN, REFRIGERATOR, DISHWASHER AND OR COMPACTOR. THE LOCATION OF CONTROLS FOR RANGE COOKTOPS SHALL NOT REQUIRE REACHING ACROSS BURNERS.
- THE FINISHED FLOOR IS TO CONTINUE AND THE CABINETRY AND WALL SURFACES FINISHED UNDER CABINETS WITH REMOVABLE DOORS FOR HANDICAP FORWARD APPROACH.
- PROVIDE SOLID 2X FIRE BLOCKING AT ALL CEILING AND FLOOR LEVELS, TOPS AND BOTTOMS OF STAIRWAYS, AND AT DROPPED CEILING LOCATIONS.

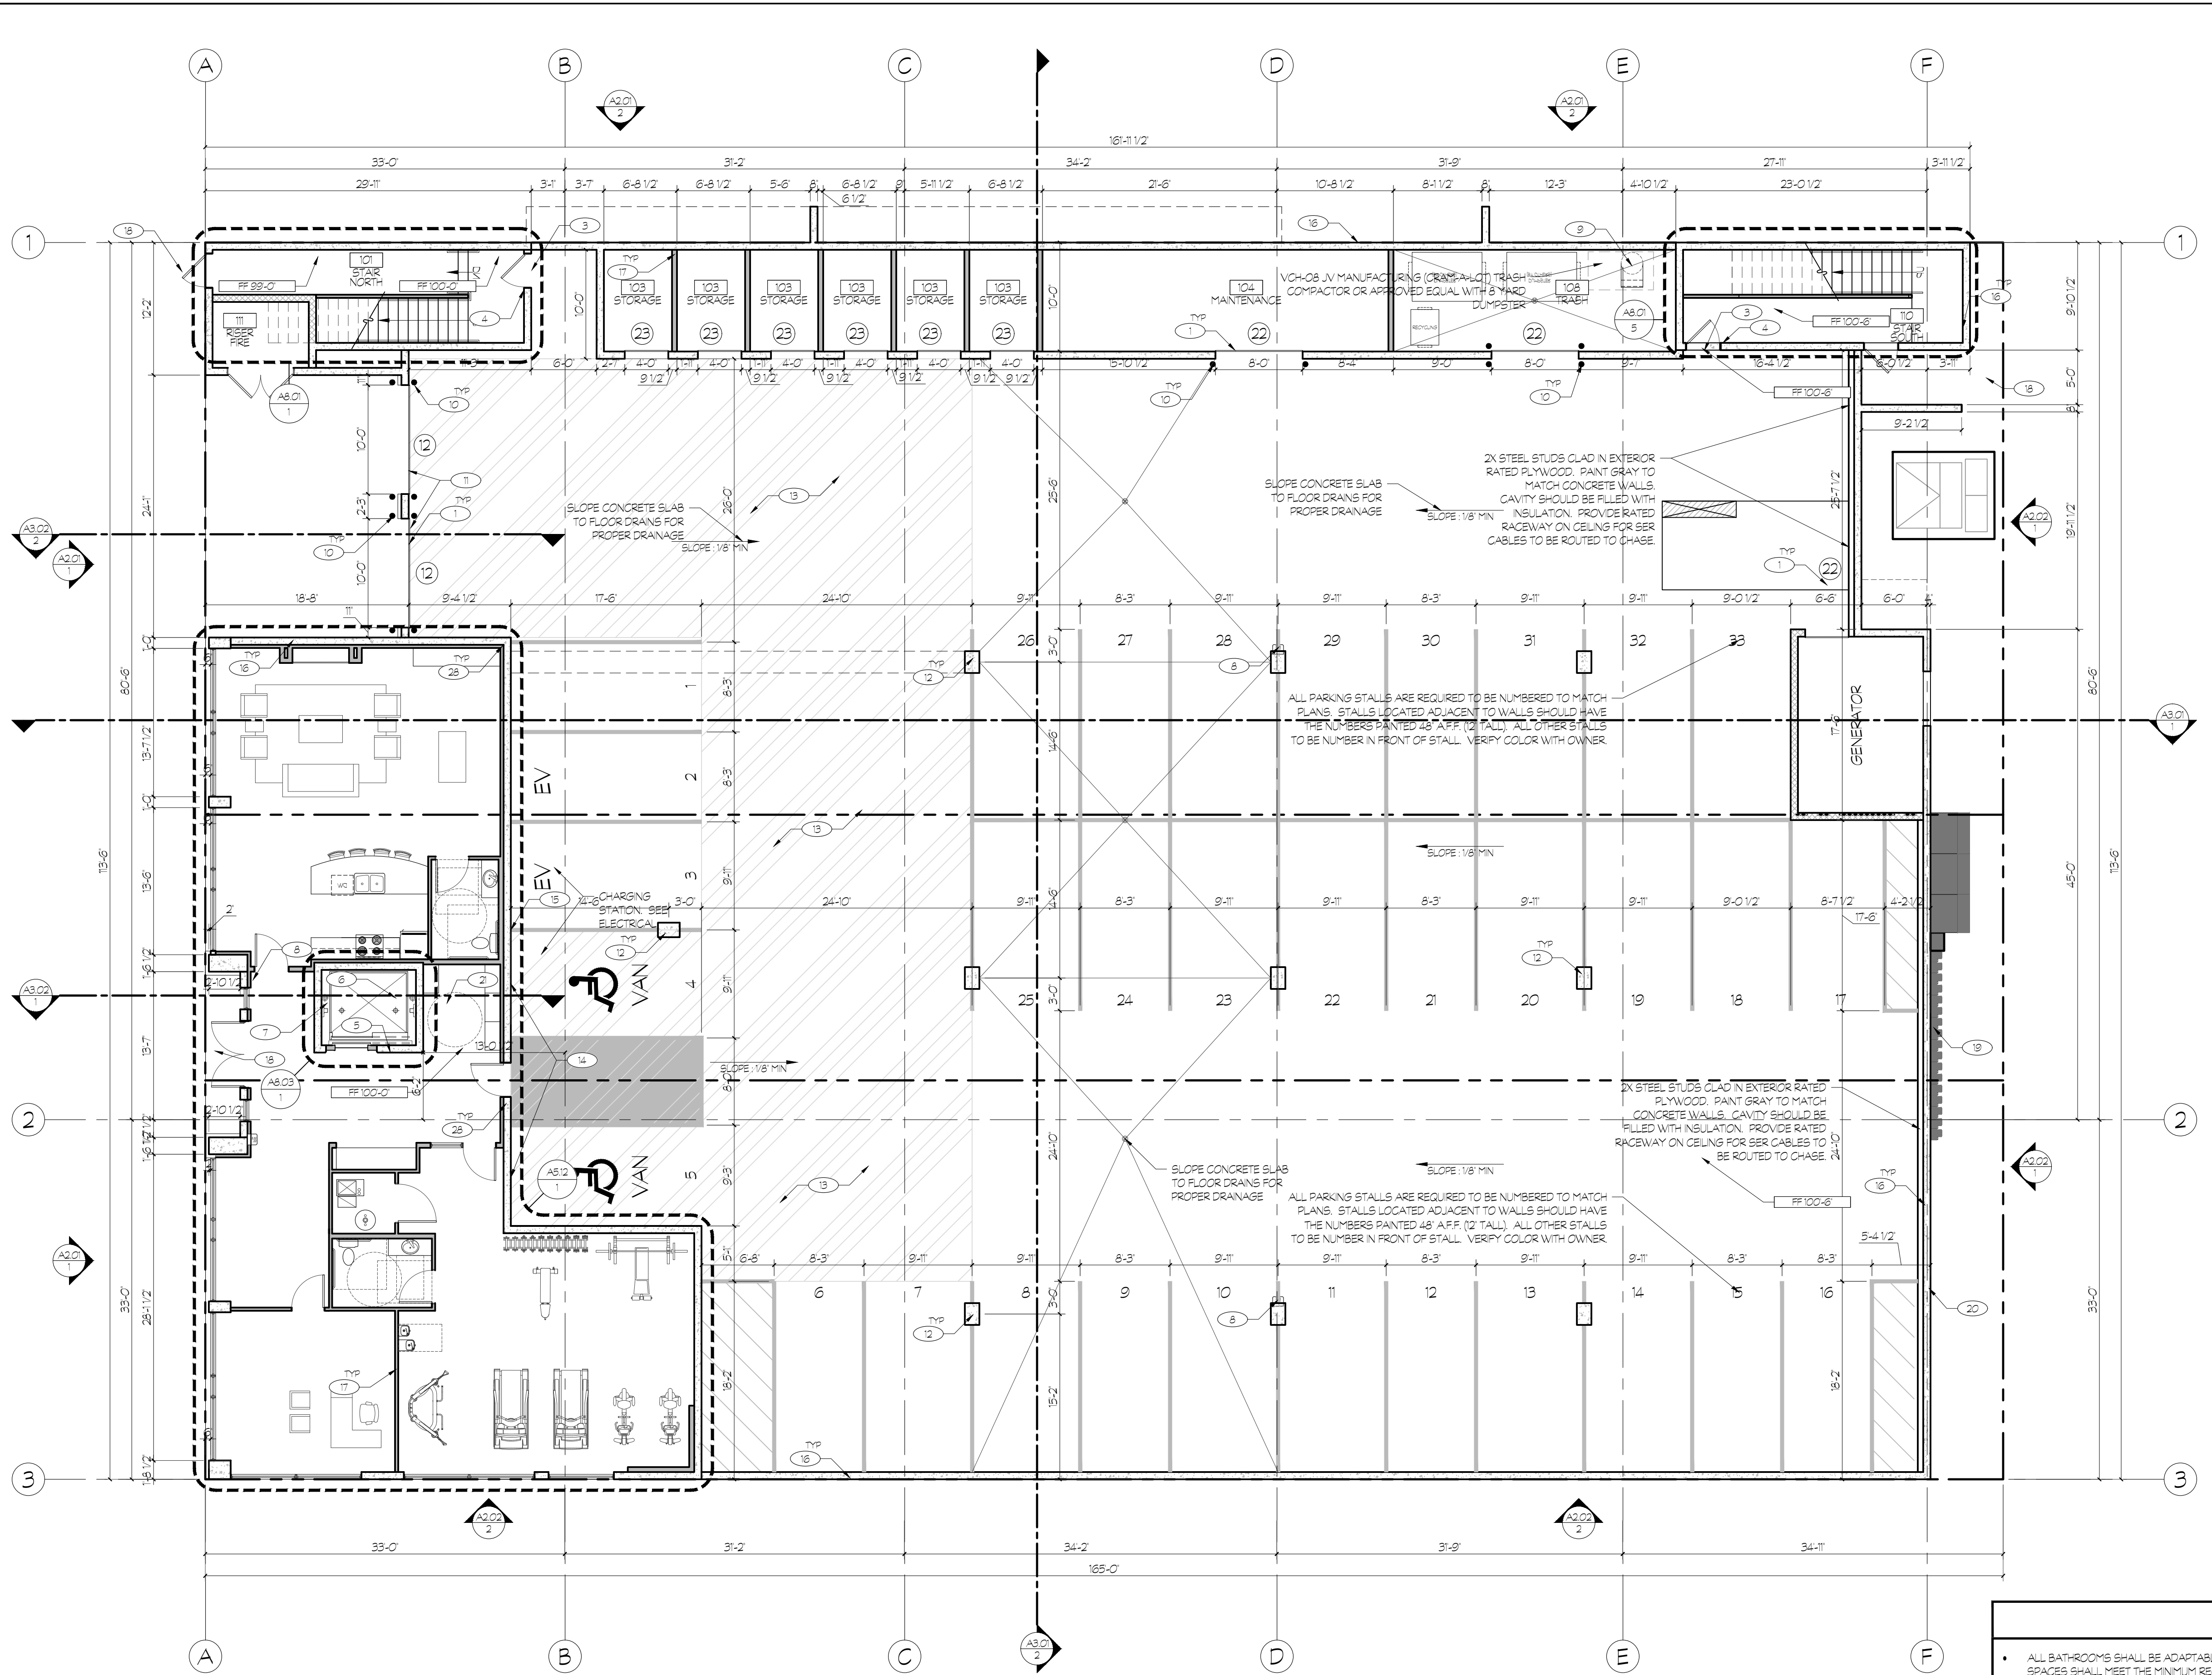

**1 OVERALL FLOOR PLAN**  
A1.01 SCALE: 1/8" = 1'-0"  
(24" x 36")

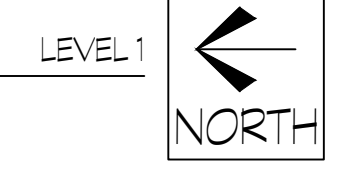

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1 OVERALL PT DECK PLAN BETWEEN LEVELS 1 & 2  
 A1.02 SCALE: 1/8" = 1'-0"  
 (24' x 36')

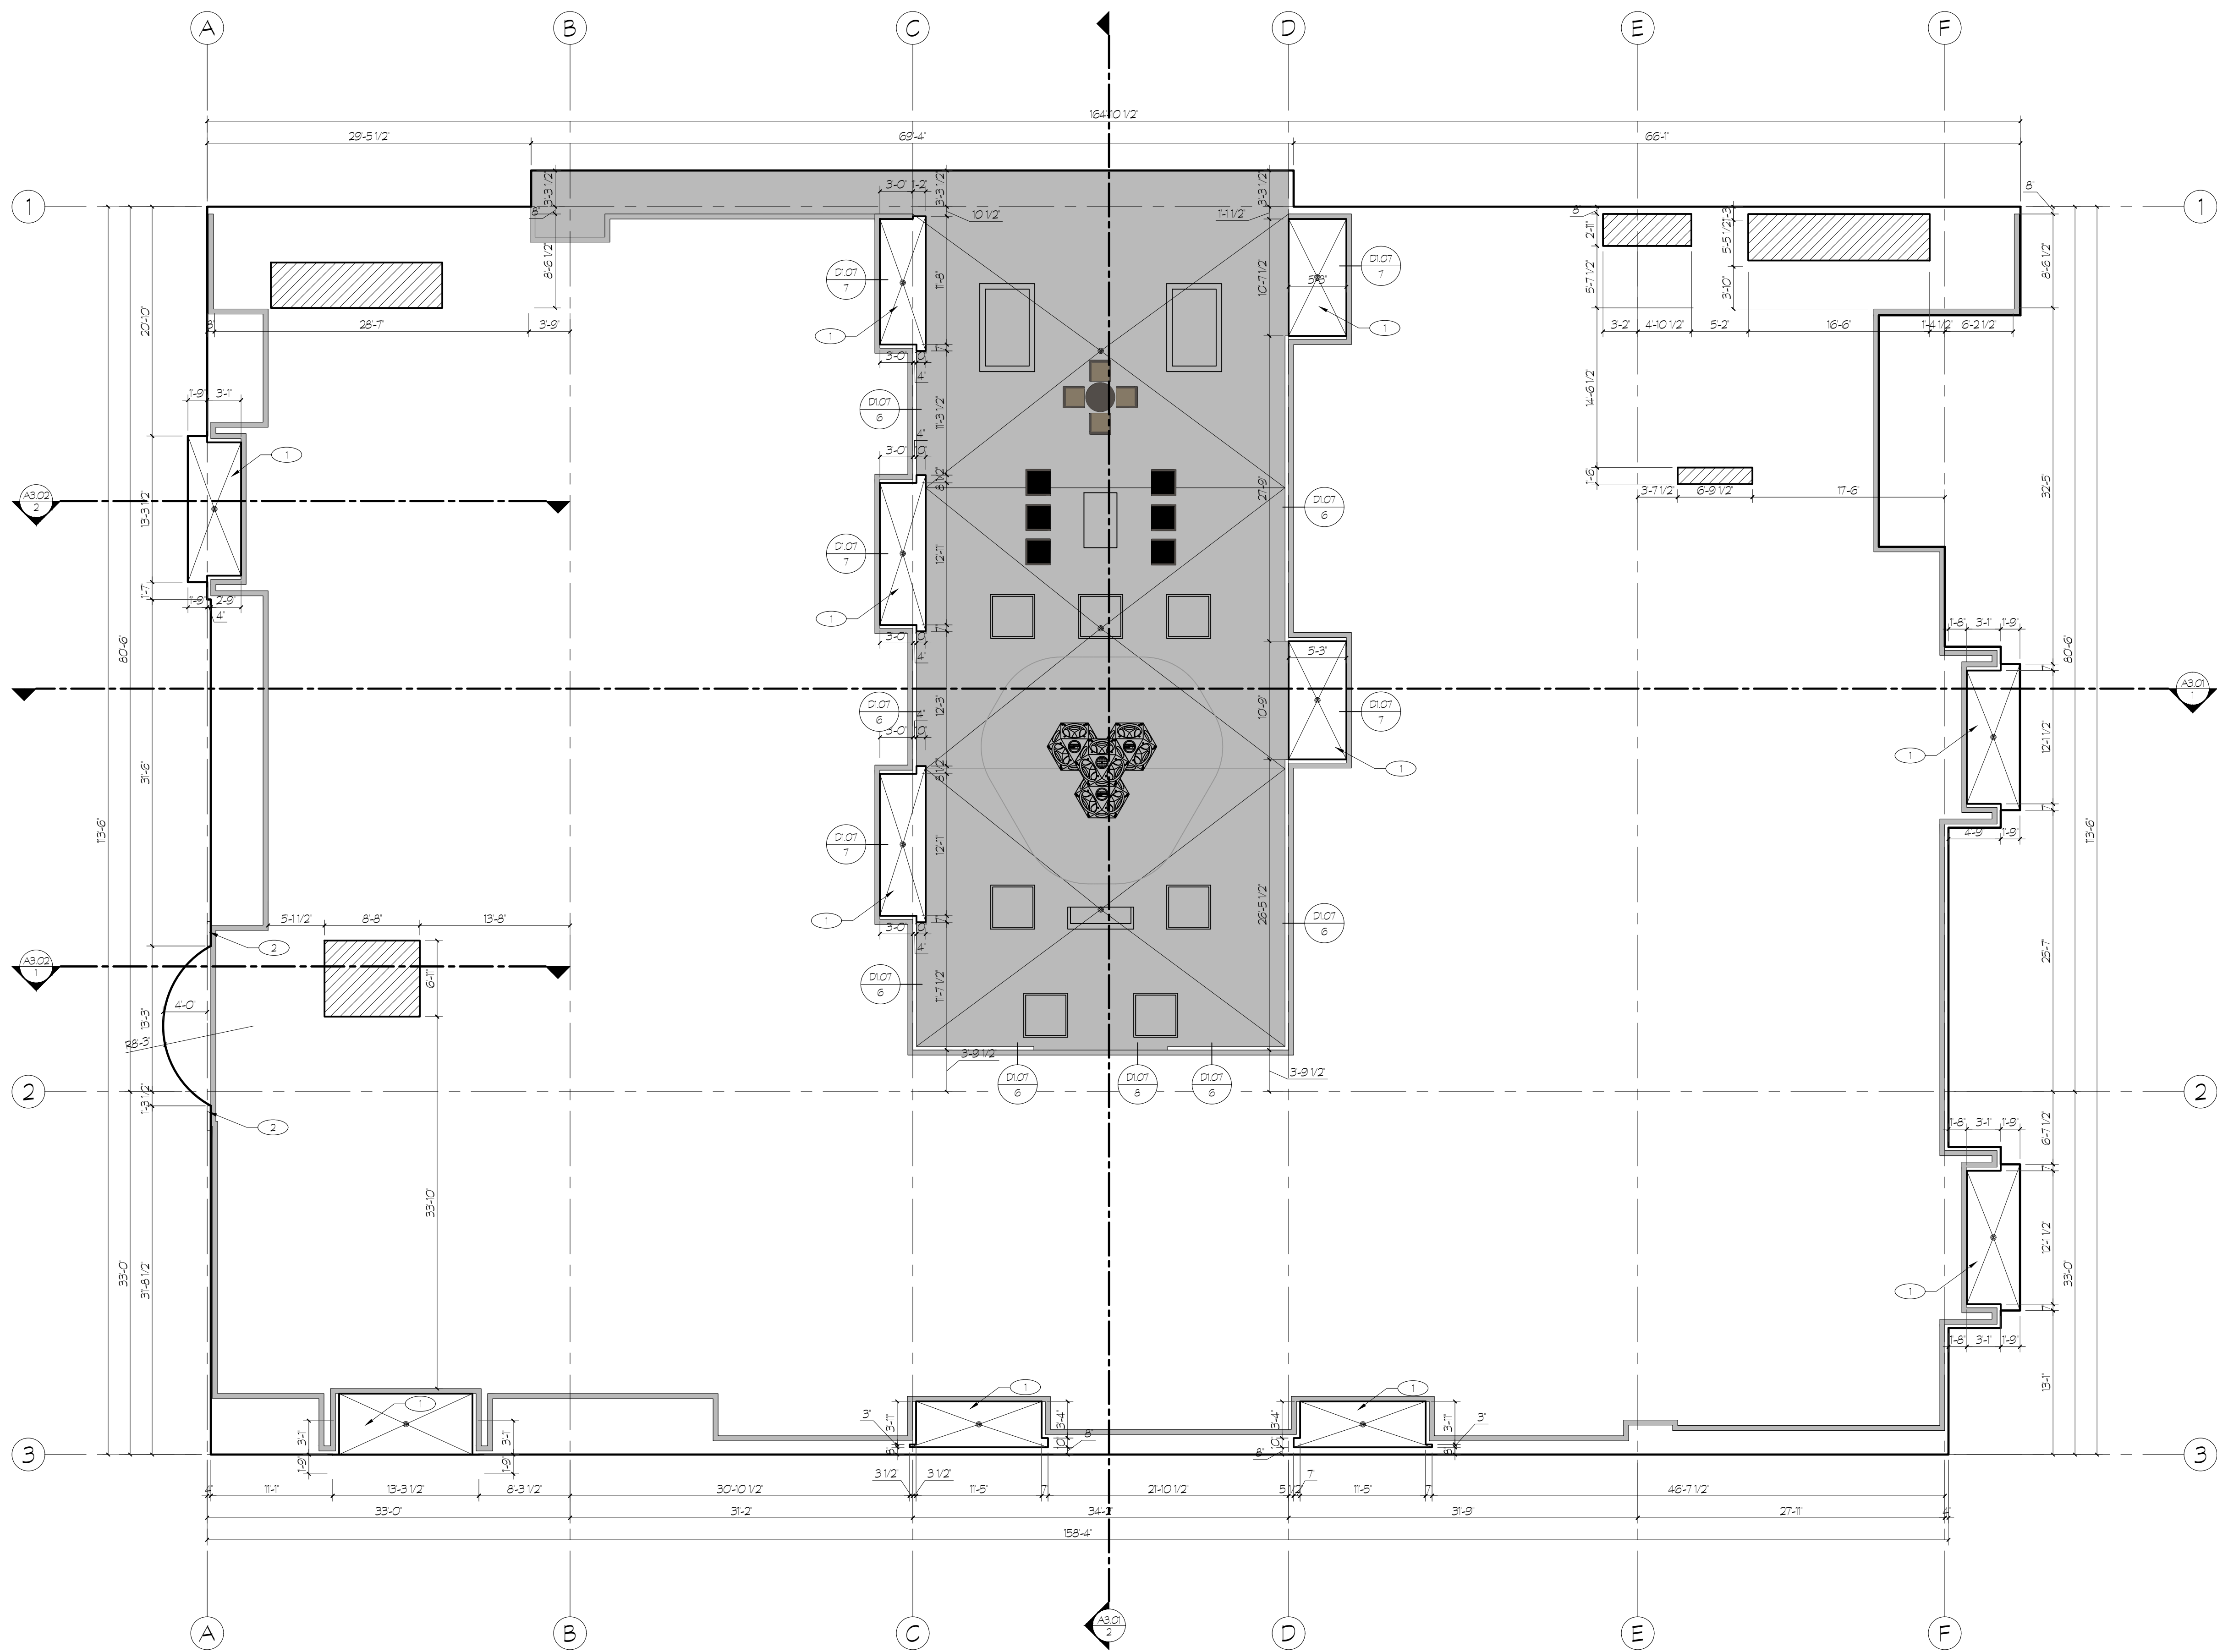**SLAB PLAN BETWEEN LEVELS 1 & 2 KEYED NOTES:**

- 1 PATIO DECKS SLOPE TO DRAIN.
- 2 BRICK CONTINUES TO GROUND LEVEL.
- 3 MOVEABLE PLANTER. SEE LANDSCAPE PLANS.
- 4 SHADED AREA REPRESENTS STAINED CONCRETE. SEE LANDSCAPE PLANS.

**SLAB PLAN BETWEEN LEVELS 1 & 2 GENERAL NOTES:**

- SEE SHEET A1.03 FOR ALL WINDOW AND DOOR OPENINGS
- ALL DIMENSIONS AROUND THE PT DECK ARE TO THE EDGE OF THE PT DECK OR TO A GRID LINE

**SLAB PLAN BETWEEN LEVELS 1 & 2 LEGEND**

	OPENING IN PT TO ALLOW FOR ELEVATORS, STAIRS, TRASH CHUTE AND SER CHASE		STAINED CONCRETE PER KEYED NOTE 4
	LEVEL 2 WOOD FRAMING. SEE SHEET A1.03		PT PERIMETER
	BRICK EDGE		ELEVATION OF A GIVEN POINT TO SHOW EXTENT OF SLOPE

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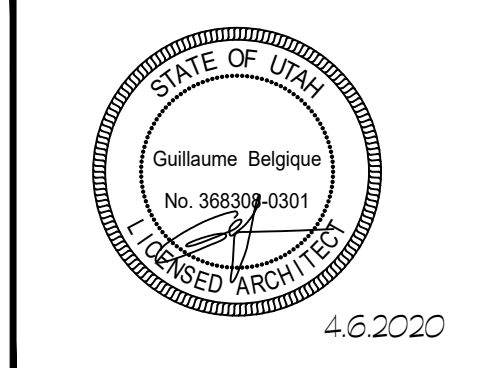
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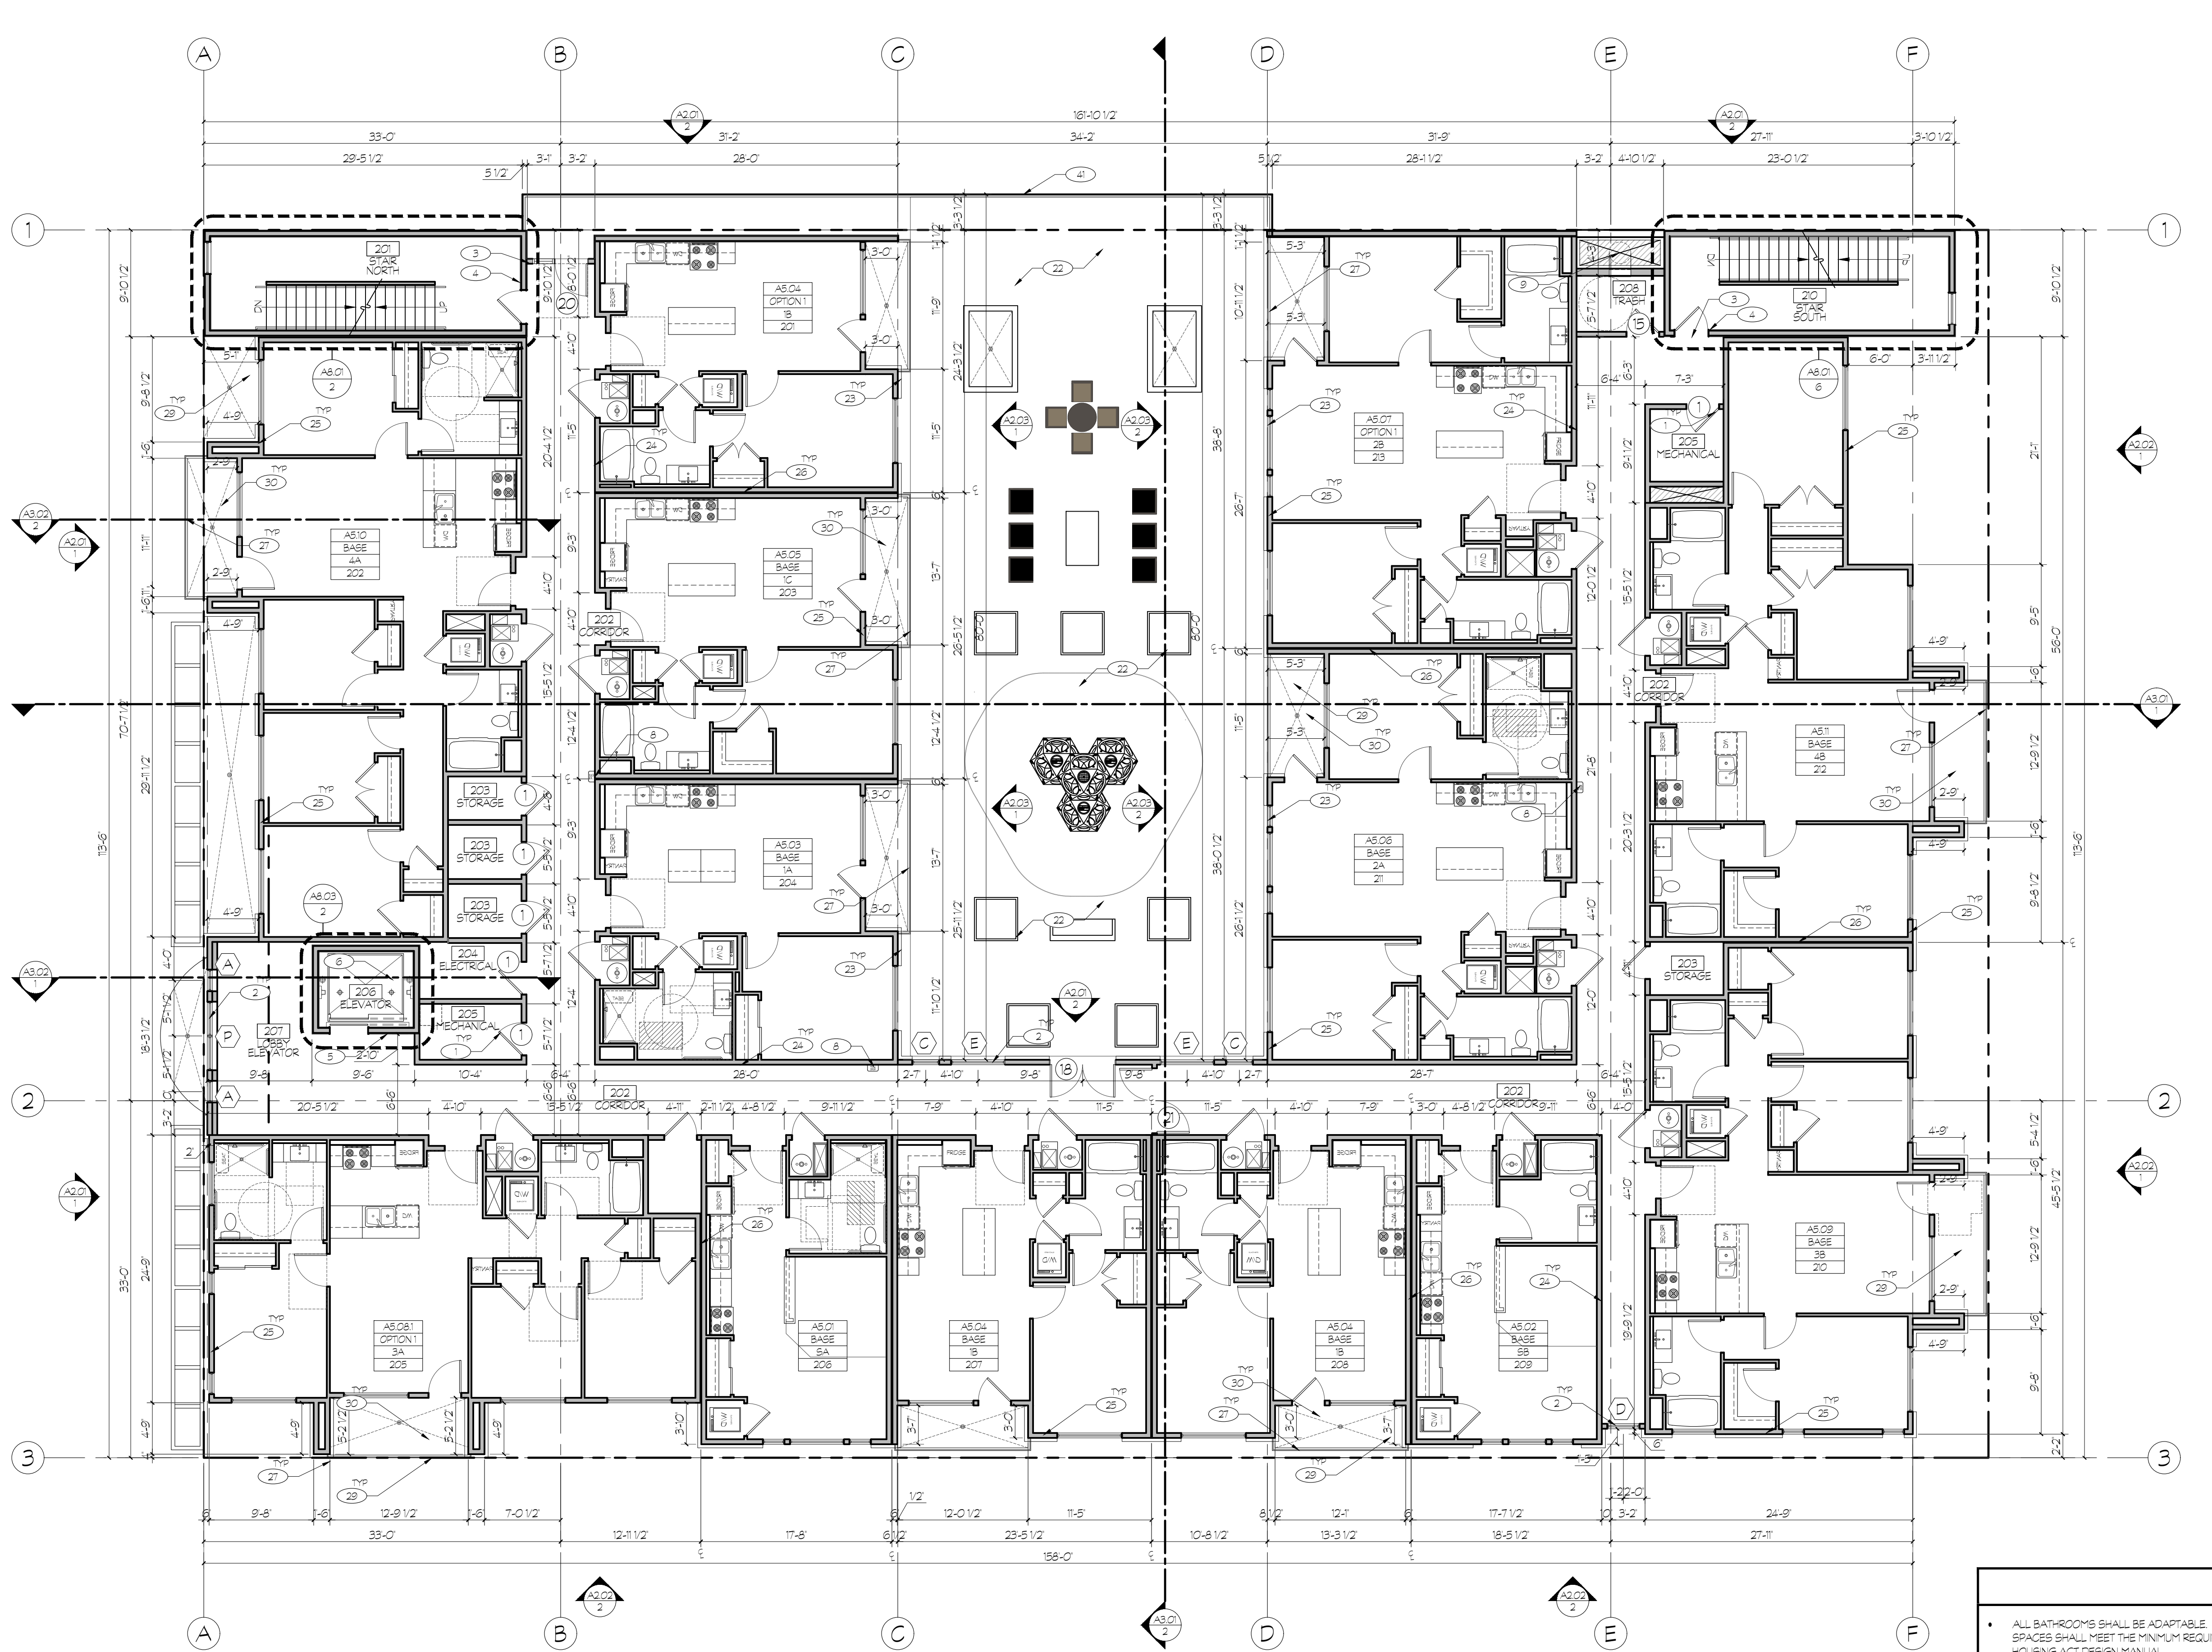
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**Sheet Title**  
 Overall PT Deck Plan  
 Between Levels 1 & 2

**Sheet Number**  
 A1.02



- OVERALL FLOOR PLAN KEYED NOTES:**
- SCHEDULED DOOR. SEE DOOR SCHEDULE, TYPES AND STYLES ON SHEET A6.01. PROVIDE AND INSTALL ALL REQUIRED DOOR FLASHING PER MANUFACTURER'S RECOMMENDATIONS.
  - SCHEDULED WINDOW. SEE WINDOW SCHEDULE, TYPES AND STYLES ON SHEET A6.02. PROVIDE AND INSTALL ALL REQUIRED FLASHING PER MANUFACTURER'S RECOMMENDATIONS.
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  - ELECTRICAL METER LOCATION. COORDINATE WITH ELECTRICAL DRAWINGS.
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  - VERIFY MAIL ROOM REQUIREMENTS WITH US POST OFFICE FOR EXACT CONFIGURATION AND NUMBER OF BOXES. SEE DETAIL 1.01.02
  - COURTYARD FINISHED PER LANDSCAPE DRAWINGS.
  - PT DECK TO STEP IN COURTYARD. SEE DETAILS 6.8.01.07 AND STRUCTURAL DRAWINGS.
  - PAINTED GYP BOARD WALL FINISH. PAINT COLOR AND BRAND TO BE OWNER SELECTED. SEE OWNERS SPEC AND INTERIOR DESIGN DRAWINGS.
  - EXTERIOR 2 HOUR RATED ASSEMBLY. SEE STRUCTURAL DRAWINGS. SEE DETAIL 2.01.01
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  - PRE-MANUFACTURED POWDER COATED STEEL DECK GUARDRAIL (42" HIGH) PER CODE (TYP). SEE DETAIL 3.01.04
  - ALL WALLS SEPARATING CONDITIONED FROM UNCONDITIONED SPACE PROVIDE 1/2" AIR GAP BETWEEN FRAMING AND CONCRETE. INSULATE & MAINTAIN GAP. PROVIDE VAPOR BARRIER ON INTERIOR SIDE.
  - 6 GAO FLUID APPLIED DECK MEMBRANE AT UNIT BALCONIES, PATIOS OVER PT DECK AND COURTYARD OVER PT DECK. INSTALL PER MANUFACTURER'S RECOMMENDATIONS. SEE DETAILS 1.2.01.04.
  - UNIT BALCONIES AND PATIOS OVER PT DECK SLOPED MIN 1/4" PER FOOT FOR DRAINAGE. SEE PLUMBING DRAWINGS FOR LOCATIONS AND PIPING OF UNIT BALCONY DRAINS.
  - CRICKETS AS NECESSARY FOR PROPER ROOF DRAINAGE.
  - CLASS B SINGLE PLY ENERGY STAR COMPLIANT TPO ROOF MEMBRANE (60 ML WITH 20 YEAR WARRANTY) OVER SCHEDULED SHEATHING AND BOX TRUSSES. SLOPE TOWARDS ROOF DRAINS. SEE STRUCTURAL AND PLUMBING DRAWINGS AND DETAIL 1.01.02. SEE DETAILS 3.4.01.08 FOR PIPE PENETRATIONS.
  - ROOF DRAINS. PRIMARY ROOF DRAIN SHALL CONNECT TO STORM SEWER. SECONDARY DRAIN SHALL DAYLIGHT OUT THROUGH BUILDING WALL AT MAIN FLOOR LEVEL WITH STANDARD BRASS FITTING. SEE PLUMBING DRAWINGS. SEE DETAILS 1.2.01.08
  - CONDENSING UNIT ON RUBBER PAD ON WOOD FRAMED PLATFORM. SLOPE PLATFORM FOR DRAINAGE ONTO ROOF. SEE MECHANICAL AND PLUMBING DRAWINGS. SEE STRUCTURAL DRAWINGS FOR FRAMING DETAIL.
  - RUBBER ROOFTOP TRAFFIC PAD SYSTEM INSTALLED PER MANUFACTURER'S RECOMMENDATIONS.
  - ROOF PARAPET. SEE PARAPET ROOF DETAILS 9.11.01.01. SEE STRUCTURAL DRAWINGS FOR ASSOCIATED LATERAL BRACINGS AND DETAILS (TYP).
  - VERIFY HEIGHT OF ELEVATOR SHAFT OVERLUN WITH ELEVATOR MANUFACTURER.
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  - MECHANICAL SHAFT ROOF PENETRATION. SEE DETAIL 3.01.08
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  - 6'-0" TALL DECORATIVE FENCE SEE DETAIL 9.01.02



**1 OVERALL FLOOR PLAN**  
A1.03 SCALE: 1/8" = 1'-0"  
(24" x 36")  
LEVEL 2  
NORTH

- GENERAL NOTES:**
- ALL BATHROOMS SHALL BE ADAPTABLE. GENERAL CONTRACTOR SHALL VERIFY THAT ALL FIXTURE LOCATIONS, SOLID BLOCKING AND CLEAR FLOOR SPACES SHALL MEET THE MINIMUM REQUIREMENTS OF THE 2015 BC, ANSI 117-1.03 AND THE REQUIREMENTS OF SPECIFICATION A BATHROOM OF THE FAIR HOUSING ACT DESIGN MANUAL.
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  - ALL ENTRY DOORS SHALL BE 36" WIDE, HAVE LEVER TYPE LATCHES AND HAVE THRESHOLDS NO HIGHER THAN 1/2" WHICH ARE BEVELLED WITH A SLOPE NO GREATER THAN 1/2". SEE DETAIL 3.01.01
  - CLEAR WIDTH OF AN ACCESSIBLE ROUTE SHALL BE 36" MINIMUM, EXCEPT AT DOORS. CLEAR WIDTH OF THE ACCESSIBLE ROUTE WITH TURNS AROUND AN OBSTRUCTION LESS THAN 48" WIDE SHALL HAVE A CLEAR SPACE OF 42" X 48".
  - ELECTRICAL SWITCHES, OUTLETS, THERMOSTATS AND OTHER ENVIRONMENTAL CONTROLS SHALL HAVE NO OPERABLE PARTS WHICH ARE HIGHER THAN 48" NOR LESS THAN 15" A.F.F.
  - ALL UNITS ARE TO BE PROVIDED WITH SOLID BLOCKING BETWEEN STUDS IN THE BATHROOM WALLS BEHIND THE TOILET AND AROUND THE TUB AND BETWEEN THE WALL & THE BACK SURFACE OF THE TUB / SHOWER SPLASH FOR THE POSSIBLE FUTURE INSTALLATION OF GRAB BARS. (POSSIBLE FUTURE GRAB BAR AT THE SIDE OF THE TOILET WOULD BE EITHER A WALL-TO-FLOOR TYPE OR FOLD-DOWN TYPE). SEE ENLARGED BATHROOM PLANS.
  - A CLEAR FLOOR SPACE AT LEAST 30" X 48" THAT ALLOWS EITHER A FORWARD OR A PARALLEL APPROACH BY A PERSON IN A WHEELCHAIR SHALL BE PROVIDED AT ALL APPLIANCES IN THE KITCHEN, INCLUDING THE RANGE / COOKTOP, OVEN, REFRIGERATOR, DISHWASHER AND OR COMPACTOR. THE LOCATION OF CONTROLS FOR RANGE / COOKTOPS SHALL NOT REQUIRE REACHING ACROSS BURNERS.
  - THE FINISHED FLOOR IS TO CONTINUE AND THE CABINETRY AND WALL SURFACES FINISHED UNDER CABINETS WITH REMOVABLE DOORS FOR HANDICAP FORWARD APPROACH.
  - PROVIDE SOLID 2X FLOOR BLOCKING AT ALL CEILING AND FLOOR LEVELS, TOPS AND BOTTOMS OF STAIRWAYS, AND AT DROPPED CEILING LOCATIONS.

**Date**

DATE	REVISIONS


**Sheet Title**

Overall Floor Plan Level 2

**Sheet Number**

A1.03

THESE PLANS ARE INSTRUMENTS OF PROFESSIONAL SERVICE. THEY ARE THE INTELLECTUAL PROPERTY OF ARCHITECTURE BELGIQUE, INC. AND ARE PROTECTED BY COMMON LAW, STATUTORY AND OTHER RESERVED RIGHTS INCLUDING, BUT NOT LIMITED TO, COPYRIGHT. THEY MAY NOT BE REPRODUCED OR USED FOR ANY PURPOSE WITHOUT THE WRITTEN CONSENT OF ARCHITECTURE BELGIQUE, INC.

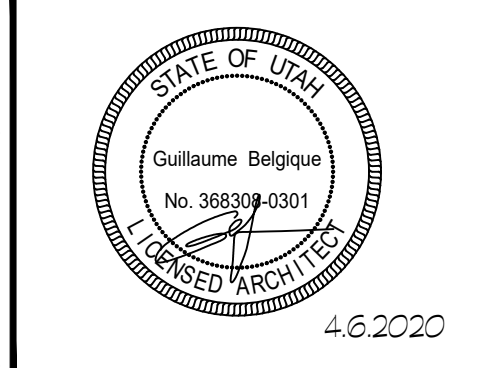

**CENTRAL WEST**  
579 WEST 200 SOUTH  
SALT LAKE CITY, UT

Date

DATE	REVISIONS

Sheet Title  
Overall Floor Plan Level 3


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**OVERALL FLOOR PLAN KEYED NOTES:**

- SCHEDULED DOOR. SEE DOOR SCHEDULE, TYPES AND STYLES ON SHEET A6.01. PROVIDE AND INSTALL ALL REQUIRED DOOR FLASHING PER MANUFACTURER'S RECOMMENDATIONS.
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- TACTILE SIGN STATING "EXIT" AND COMPLYING WITH ICC A117.1 IS TO BE PROVIDED ADJACENT TO EACH DOOR TO AN EGRESS STAIRWAY (BC SECTION 101.3).
- FLOOR LEVEL IDENTIFICATION SIGNS IN TACTILE CHARACTERS COMPLYING WITH ICC A117.1 SHALL BE LOCATED AT EACH FLOOR LEVEL LANDINGS ADJACENT TO THE DOOR LEADING TO THE CORRIDOR. SEE DETAIL 3/D1.01. BC 1022.81
- G.C. TO PROVIDE TACTILE EXIT SIGNS WHICH READ "IN CASE OF FIRE, ELEVATORS ARE OUT OF SERVICE. USE STAIRS" IN COMPLIANCE WITH SECTION 3002.3 OF THE BC.
- SCHINDLER 3300 XL MACHINE-ROOM-LESS PASSENGER ELEVATOR (3500 & 4000 LB CAPACITY AND 200FPM SPEED) WITH STAINLESS STEEL DOOR AND CAB (8'-0" TALL) INSTALLED BY ELEVATOR MANUFACTURER. COORDINATE WITH MANUFACTURER ELECTRICAL, MECHANICAL AND HOIST REQUIREMENTS. SEE ELECTRICAL AND MECHANICAL DRAWINGS. ELEVATOR CAR SHALL ACCOMMODATE A 24-INCH BY 84-INCH AMBULANCE STRETCHER IN THE HORIZONTAL OPEN POSITION AND SHALL BE IDENTIFIED BY THE INTERNATIONAL SYMBOL FOR EMERGENCY MEDICAL SERVICES (STAR OF LIFE) THE SYMBOL SHALL NOT BE LESS THAN 3-INCHES HIGH AND SHALL BE PLACED INSIDE ON BOTH SIDES OF THE HOISTWAY DOOR FRAME. BC SECTION 3002.4
- FOUNDATION WALLS AT ELEVATOR PIT PER STRUCTURAL DRAWINGS. SEE DETAIL 12/D1.02 FOR CONTINUOUS WATERPROOFING AT EXTERIOR FACE BELOW GRADE. LOCATE BUCKET IN CORNER OF PIT FOR FUTURE SLUMP PUMP.
- FIRE EXTINGUISHER CABINET. SEE DETAIL 1/D1.01
- VERIFY OPENING SIZE AND DETAILS WITH TRASH CHUTE MANUFACTURER. TRASH CHUTE OPENINGS TO BE PROTECTED WITH 90 MIN FIRE RATED SELF-CLOSING DOORS AND BE FIRE SPRINKLED PER BC 903.2112. TRASH CHUTE TO BE PROVIDED WITH SANITIZING SYSTEM.
- 6" CONCRETE FILLED STEEL PIPE BOLLARDS MIN 3'-0" HIGH AND 3'-0" DEEP IN CONCRETE FOOTING (SURFACE MOUNTED WHEN IN PT DECK)
- HIGH SPEED ALBANY GARAGE DOOR. PROVIDE 5 GARAGE DOOR OPENERS. GARAGE DOOR TO BE OPENED BY BA (BARCODE AUTOMATION INC.) DUAL BEAM DECAL SCANNER. BA-440 OR APPROXIMATELY EQUAL. PROVIDE MIN 50 TOTAL STOCKERS THAT ARE BLACK ON BLACK. EXITING GARAGE TO BE CONTROLLED BY MOTION SENSOR.
- CONCRETE COLUMNS TO HAVE SMOOTH ARCHITECTURAL FINISH WITH CHAMFERED CORNERS.
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- 6'-0" TALL DECORATIVE FENCE SEE DETAIL 9/D1.02

**GENERAL NOTES:**


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**1 OVERALL FLOOR PLAN**  
A1.04 SCALE: 1/8" = 1'-0"  
(24" x 36")  
LEVEL 3  
NORTH



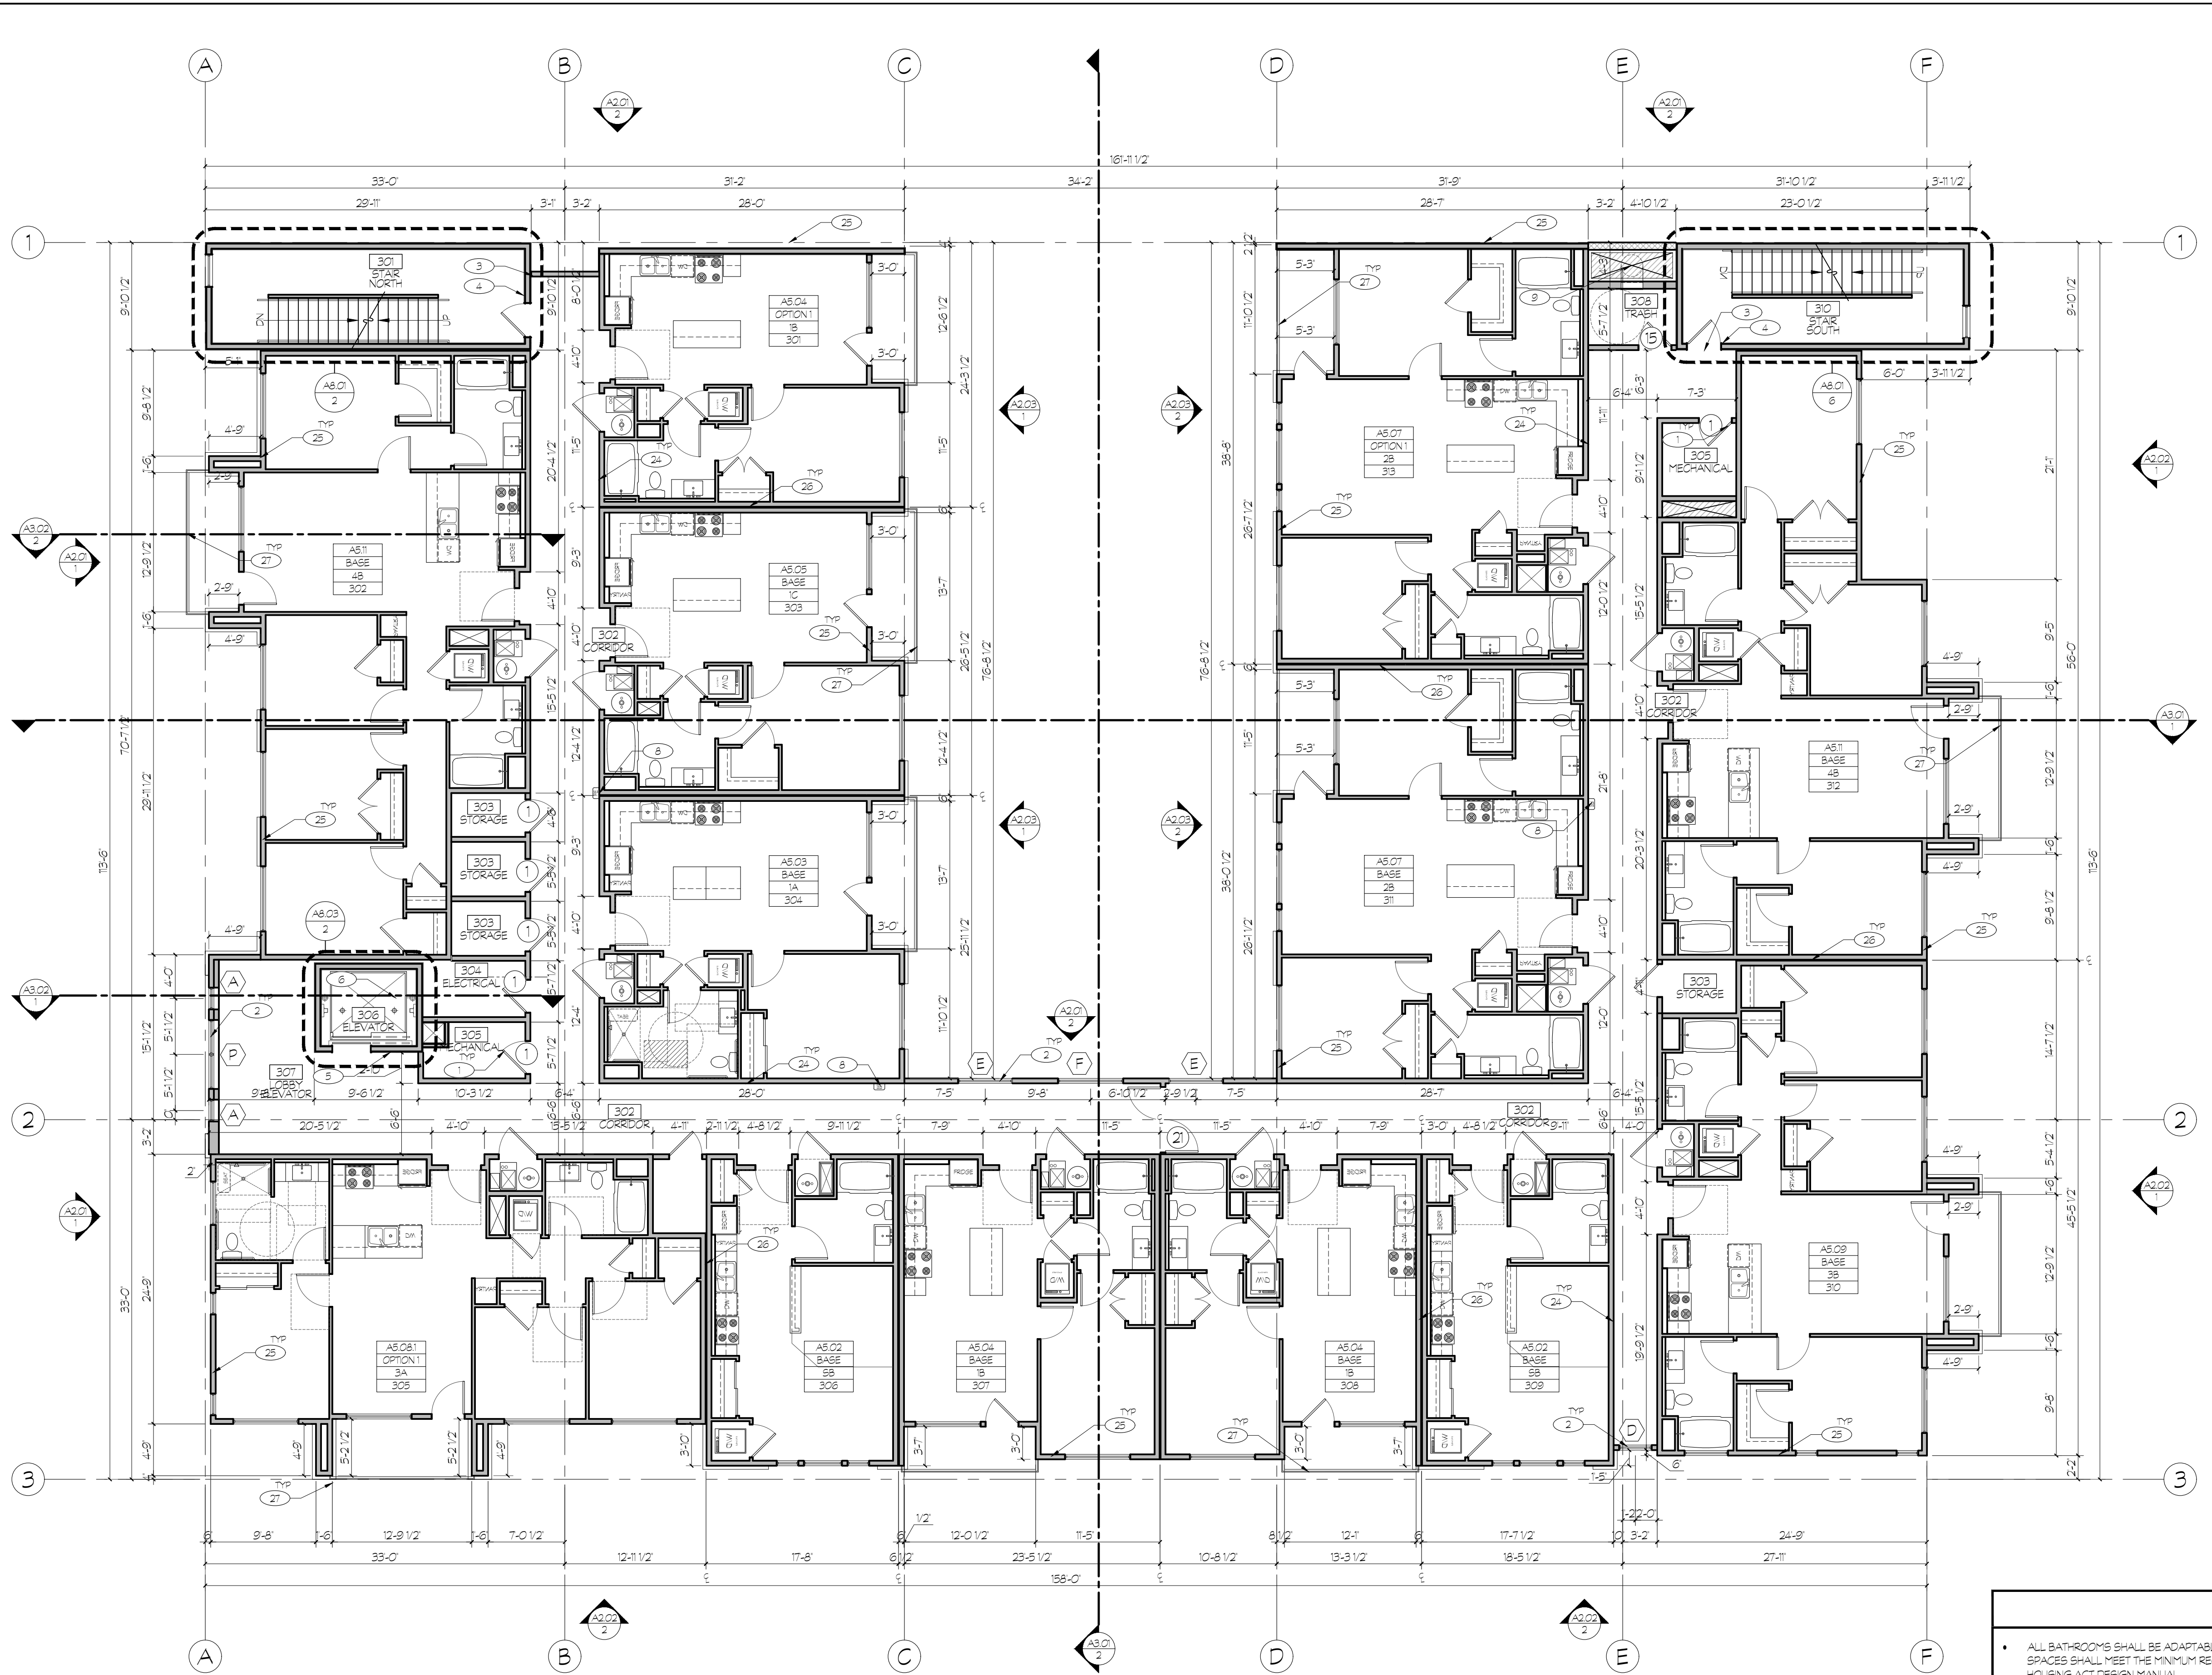



**CENTRAL WEST**  
579 WEST 200 SOUTH  
SALT LAKE CITY, UT

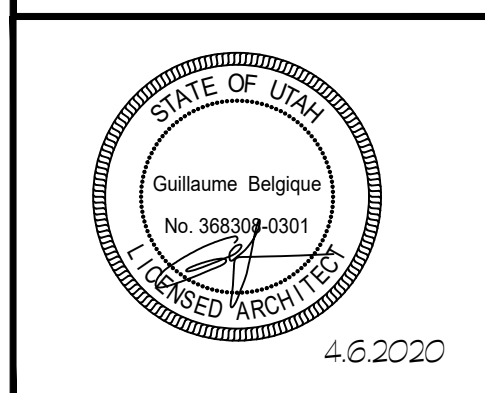Date

DATE	REVISIONS

Sheet Title

Overall Floor Plan Level 5

Sheet Number


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OVERALL FLOOR PLAN KEYED NOTES:

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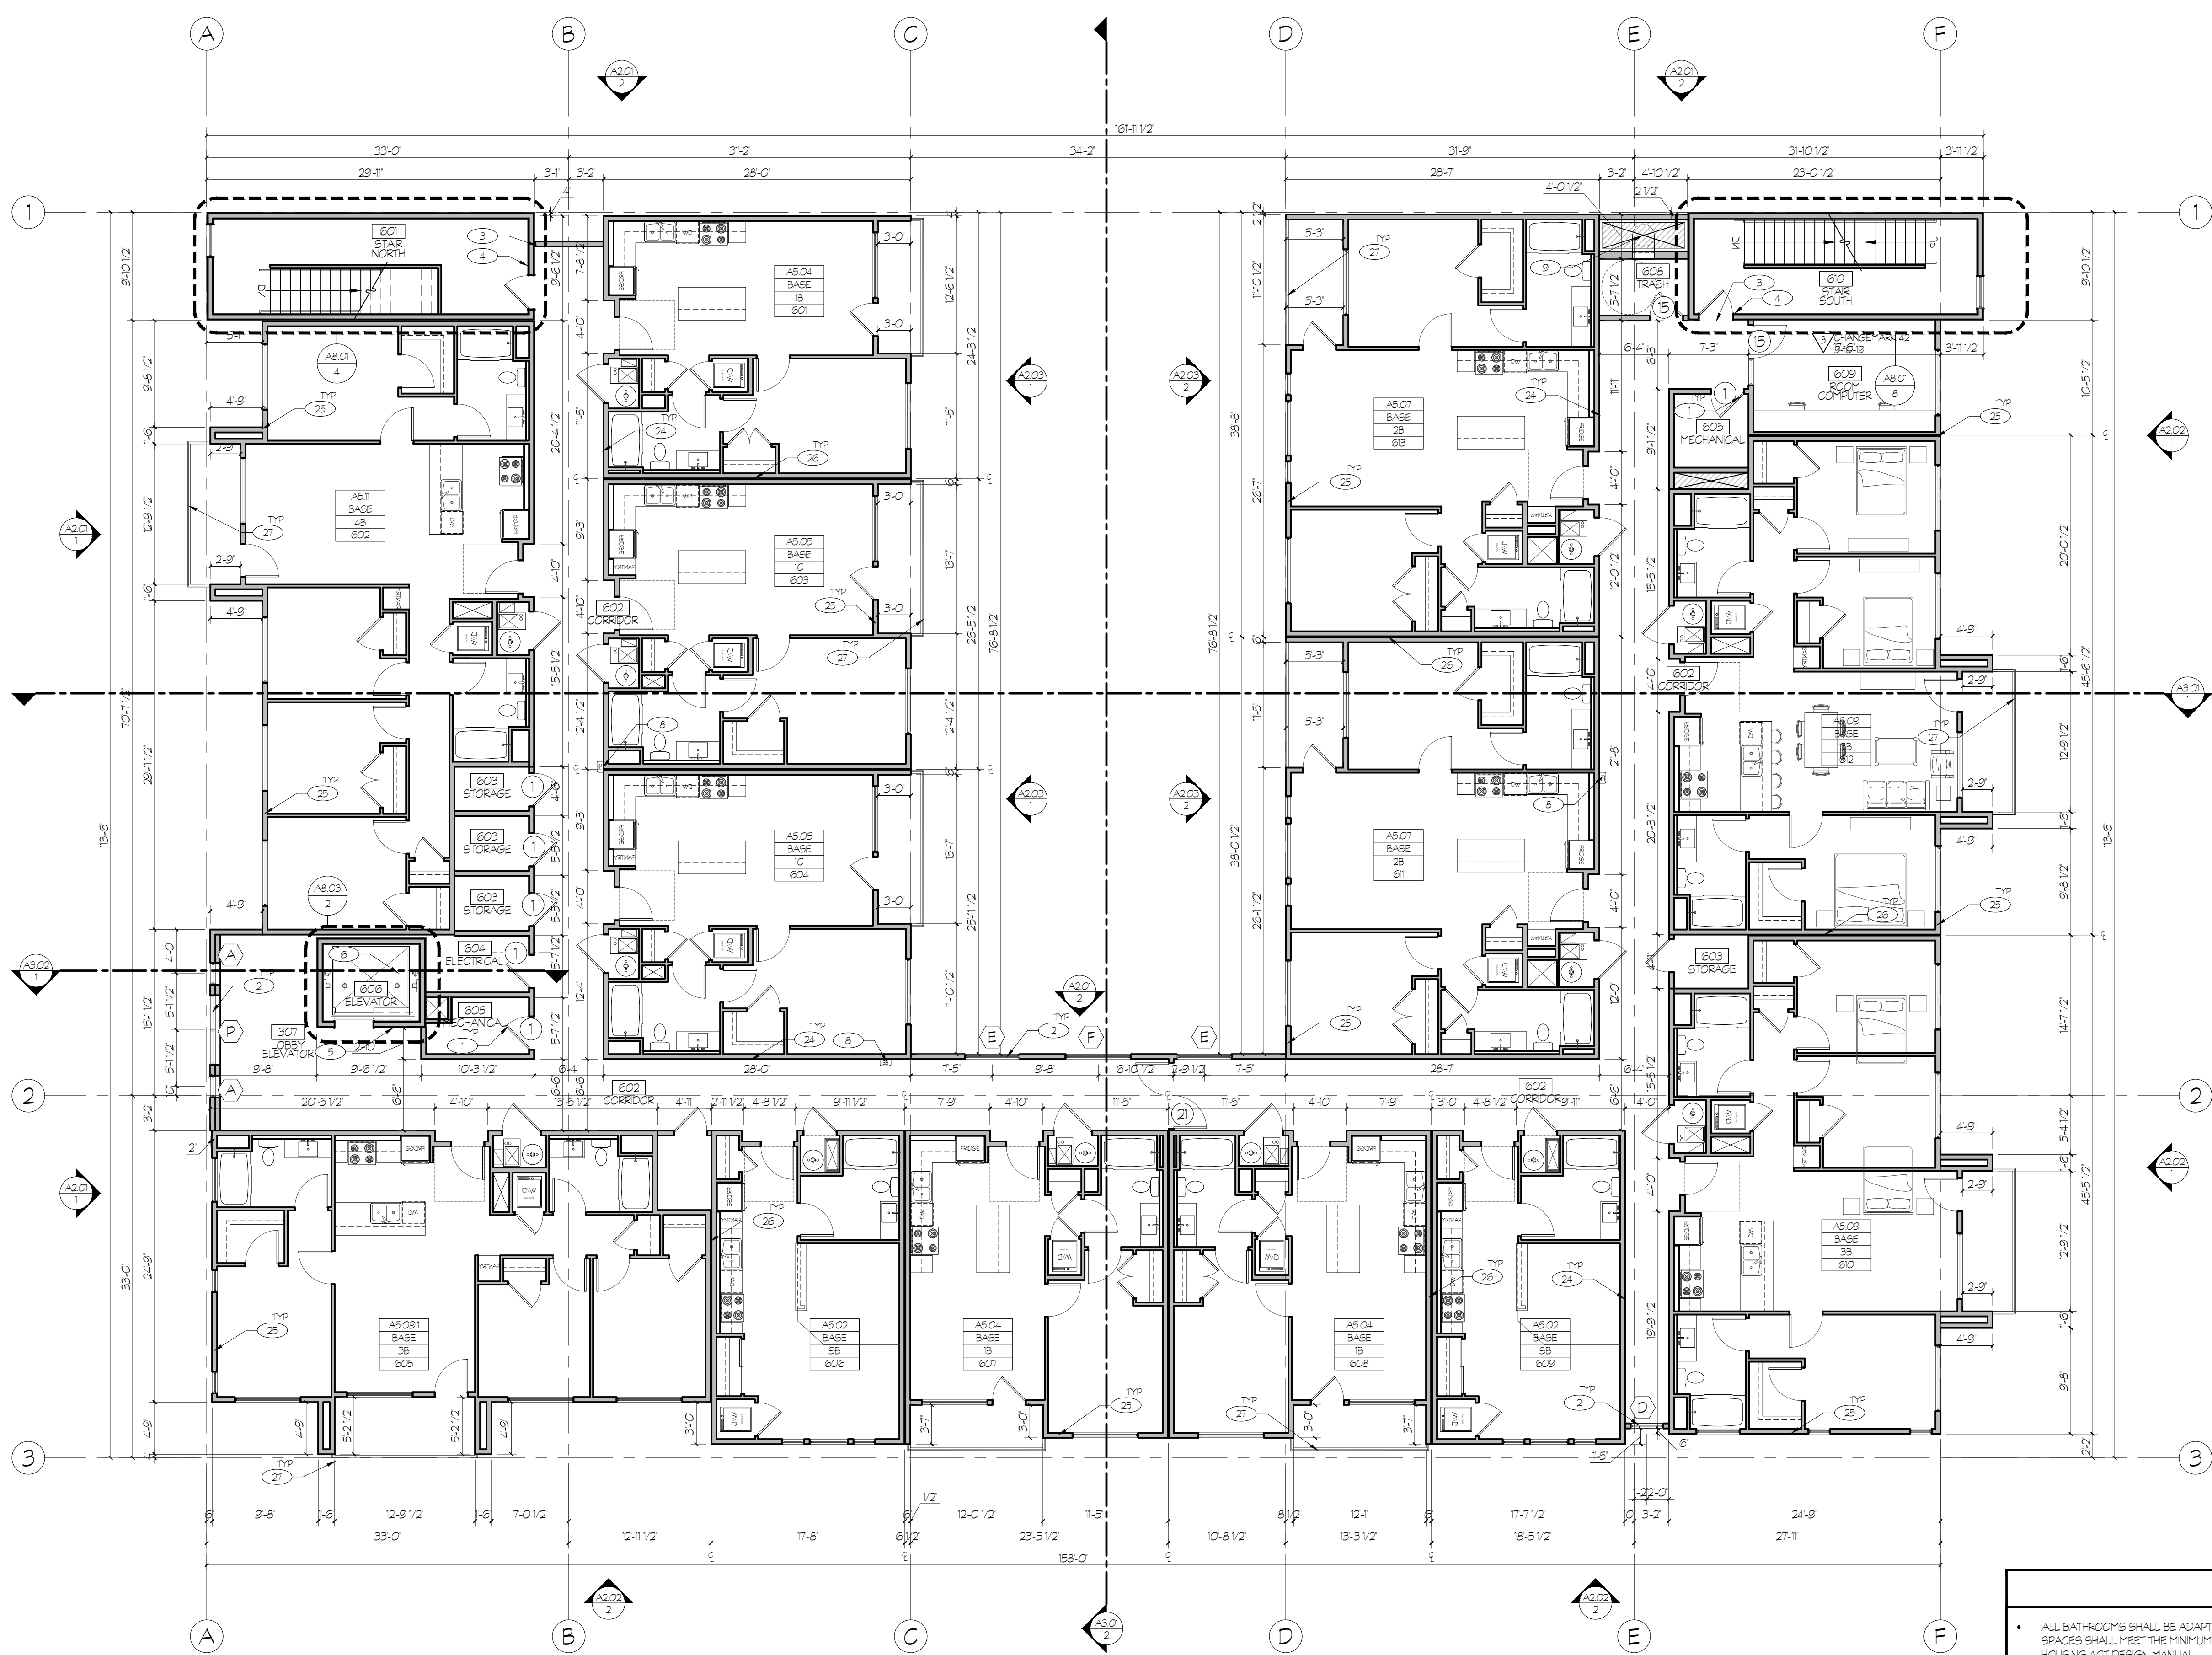
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- A CLEAR FLOOR SPACE AT LEAST 30" X 48" THAT ALLOWS EITHER A FORWARD OR A PARALLEL APPROACH BY A PERSON IN A WHEELCHAIR SHALL BE PROVIDED AT ALL APPLIANCES IN THE KITCHEN, INCLUDING THE RANGE/COOKTOP, OVEN, REFRIGERATOR, DISHWASHER AND OR COMPACTOR. THE LOCATION OF CONTROLS FOR RANGE/COOKTOPS SHALL NOT REQUIRE REACHING ACROSS BURNERS.
- THE FINISHED FLOOR IS TO CONTINUE AND THE CABINETRY AND WALL SURFACES FINISHED UNDER CABINETS WITH REMOVABLE DOORS FOR HANDICAP FORWARD APPROACH.
- PROVIDE SOLID 2X FLOOR BLOCKING AT ALL CEILING AND FLOOR LEVELS, TOPS AND BOTTOMS OF STAIRWAYS, AND AT DROPPED CEILING LOCATIONS.



1 OVERALL FLOOR PLAN LEVEL 5  
A1.06 SCALE: 1/8" = 1'-0"  
(24' x 36')

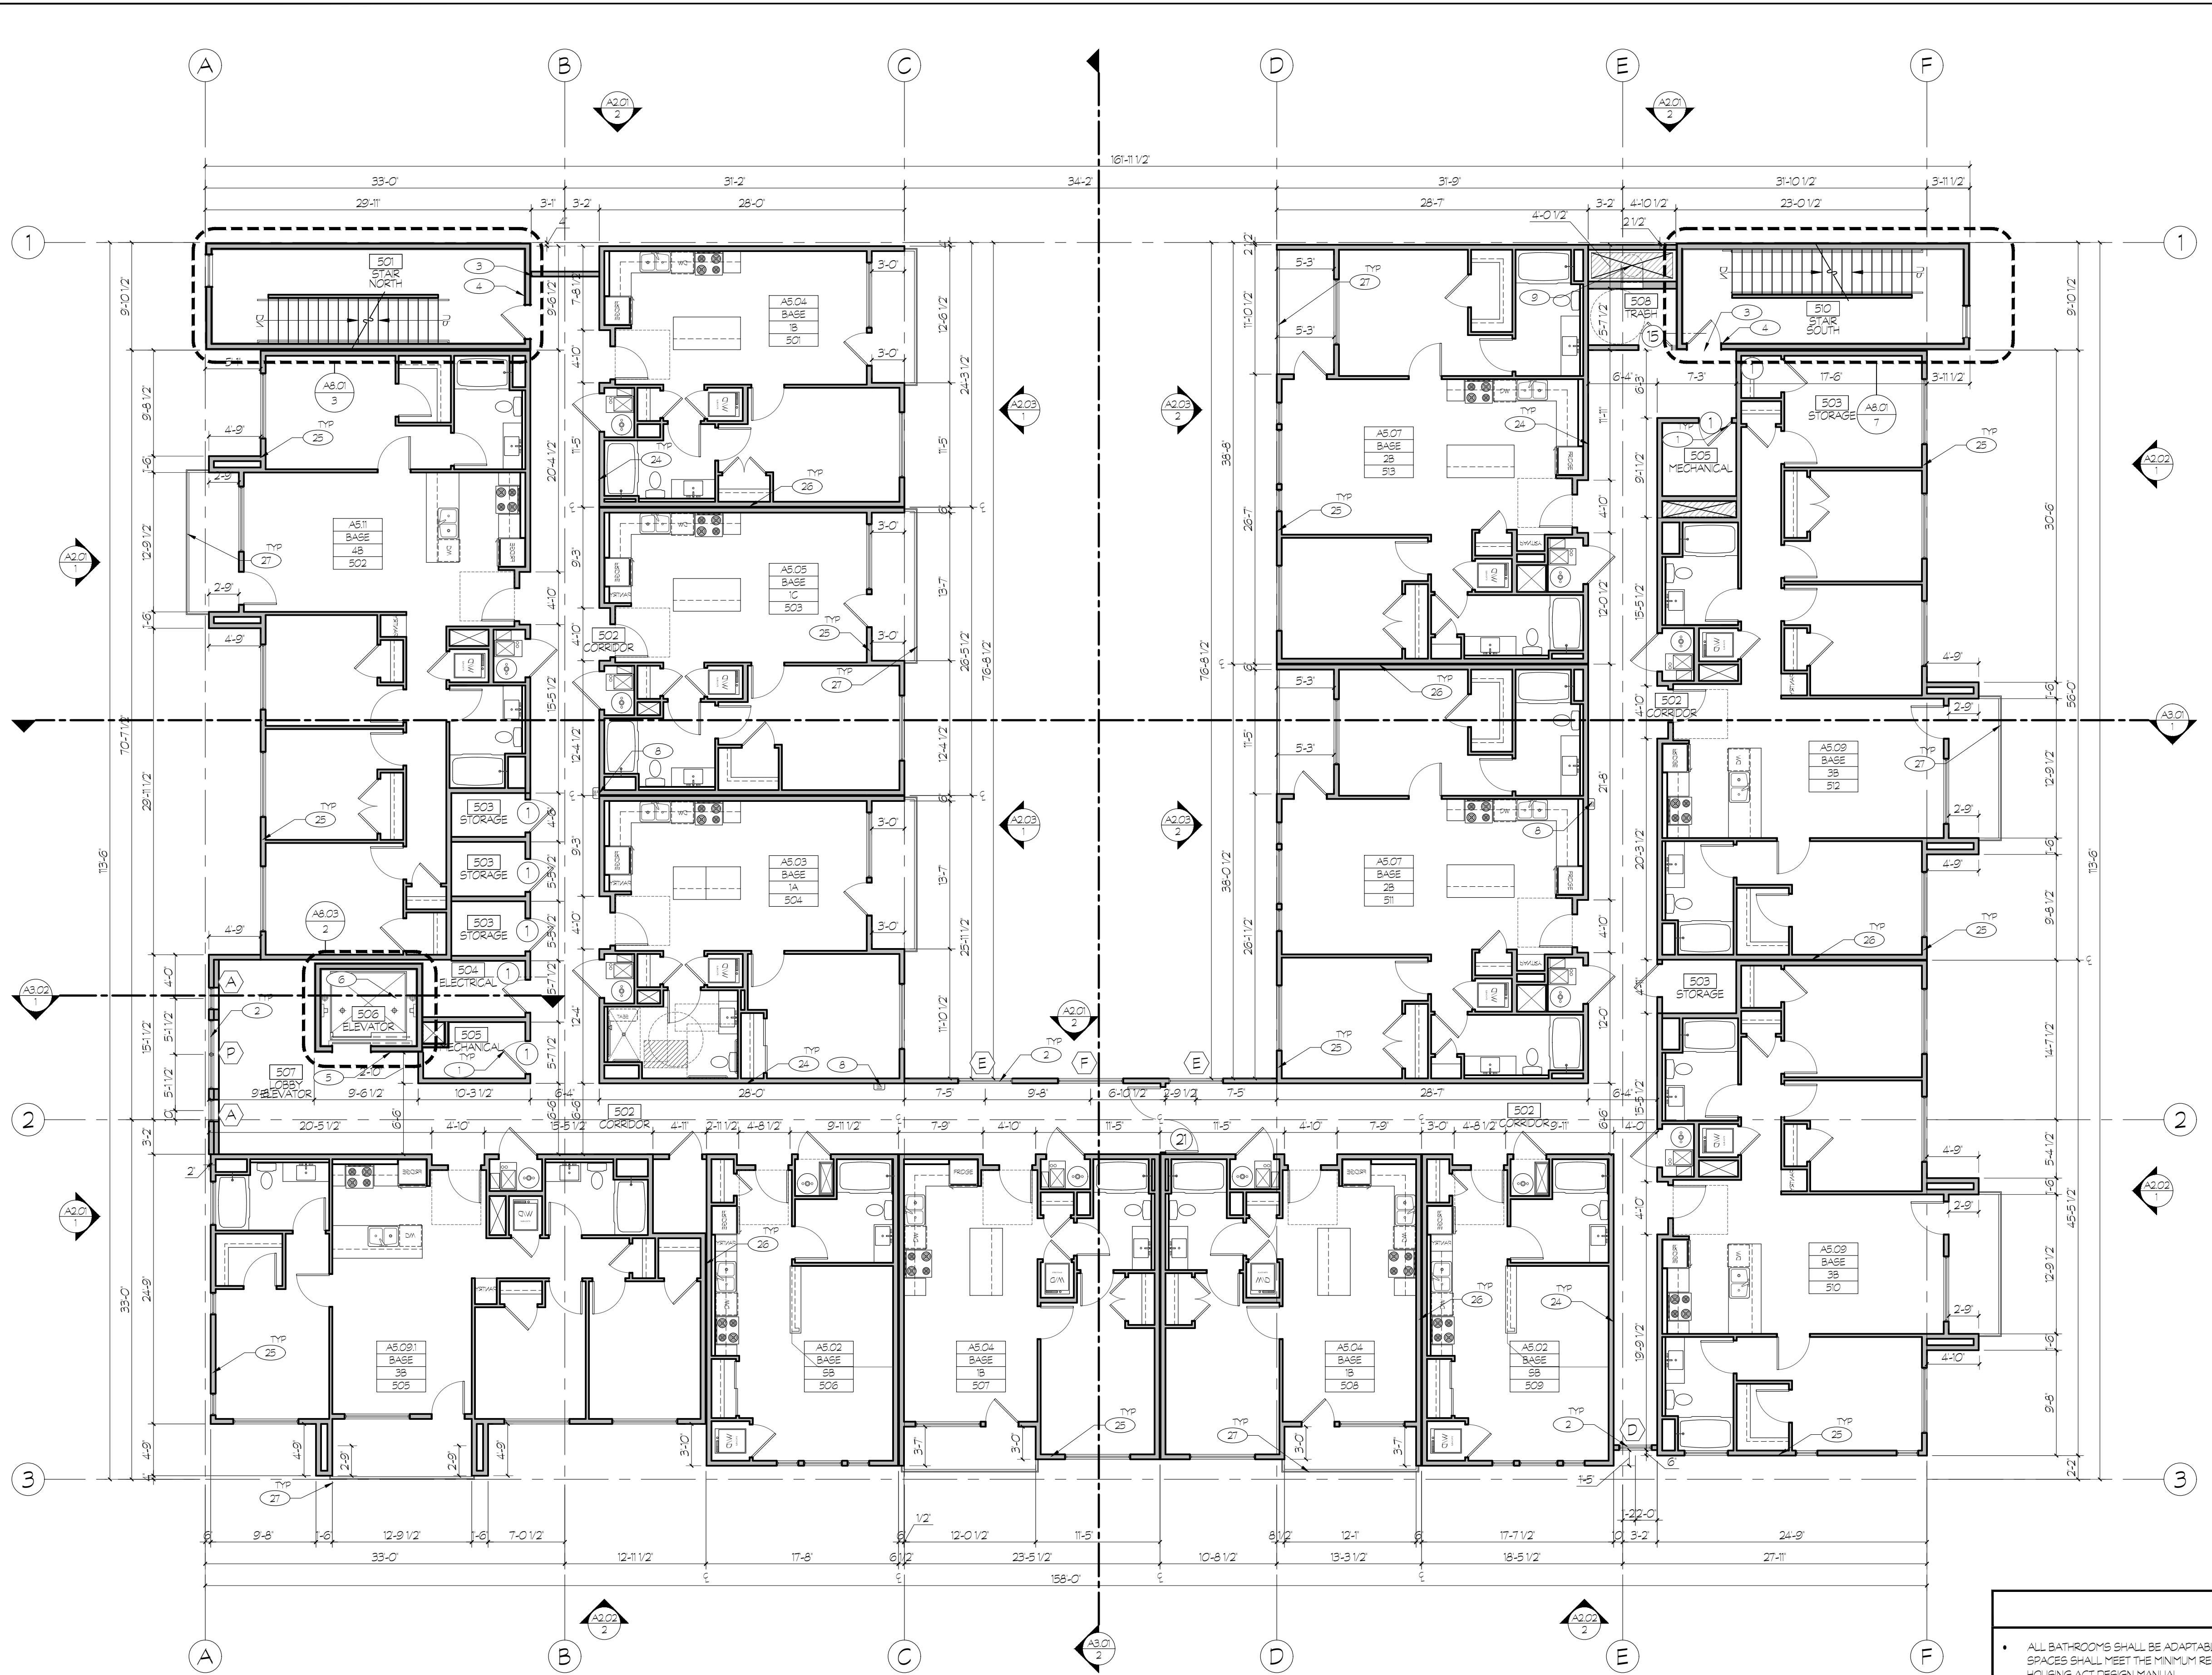

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**1 OVERALL FLOOR PLAN**  
 A1.07 SCALE: 1/8" = 1'-0"  
 (24' x 36')  
 LEVEL 6  
 NORTH

- OVERALL FLOOR PLAN KEYED NOTES:**
- SCHEDULED DOOR. SEE DOOR SCHEDULE, TYPES AND STYLES ON SHEET A6.01. PROVIDE AND INSTALL ALL REQUIRED DOOR FLASHING PER MANUFACTURER'S RECOMMENDATIONS.
  - SCHEDULED WINDOW. SEE WINDOW SCHEDULE, TYPES AND STYLES ON SHEET A6.02. PROVIDE AND INSTALL ALL REQUIRED FLASHING PER MANUFACTURER'S RECOMMENDATIONS.
  - TACTILE SIGN STATING "EXIT" AND COMPLYING WITH ICC A117.1 IS TO BE PROVIDED ADJACENT TO EACH DOOR TO AN EGRESS STAIRWAY (BC SECTION 101.3).
  - FLOOR LEVEL IDENTIFICATION SIGNS IN TACTILE CHARACTERS COMPLYING WITH ICC A117.1 SHALL BE LOCATED AT EACH FLOOR LEVEL LANDINGS ADJACENT TO THE DOOR LEADING TO THE CORRIDOR. SEE DETAIL 3/D1.01. BC 1022.81
  - G.C. TO PROVIDE TACTILE EXIT SIGNS WHICH READ "IN CASE OF FIRE, ELEVATORS ARE OUT OF SERVICE. USE STAIRS" IN COMPLIANCE WITH SECTION 3002.3 OF THE BC.
  - SCHINDLER 3300 XL MACHINE ROOM-LESS PASSENGER ELEVATOR (3500 & 4000 LB CAPACITY AND 200PM SPEED) WITH STAINLESS STEEL DOOR AND CAB (8'-0" TALL) INSTALLED BY ELEVATOR MANUFACTURER. COORDINATE WITH MANUFACTURER ELECTRICAL, MECHANICAL AND HOIST REQUIREMENTS. SEE ELECTRICAL AND MECHANICAL DRAWINGS. ELEVATOR CAR SHALL ACCOMMODATE A 24-INCH BY 64-INCH AMBULANCE STRETCHER IN THE HORIZONTAL OPEN POSITION AND SHALL BE IDENTIFIED BY THE INTERNATIONAL SYMBOL FOR EMERGENCY MEDICAL SERVICES (STAR OF LIFE) THE SYMBOL SHALL NOT BE LESS THAN 3-INCHES HIGH AND SHALL BE PLACED INSIDE ON BOTH SIDES OF THE HOISTWAY DOOR FRAME. BC SECTION 3002.4
  - FOUNDATION WALLS AT ELEVATOR PIT PER STRUCTURAL DRAWINGS. SEE DETAIL 12/D1.02 FOR CONTINUOUS WATERPROOFING AT EXTERIOR FACE BELOW GRADE. LOCATE BUCKET IN CORNER OF PIT FOR FUTURE SLUMP PUMP.
  - FIRE EXTINGUISHER CABINET. SEE DETAIL 1/D1.01
  - VERIFY OPENING SIZE AND DETAILS WITH TRASH CHUTE MANUFACTURER. TRASH CHUTE OPENINGS TO BE PROTECTED WITH 90 MIN FIRE RATED SELF-CLOSING DOORS AND BE FIRE SPRINKLED PER BC 903.2112. TRASH CHUTE TO BE PROVIDED WITH SANITIZING SYSTEM.
  - 6" CONCRETE FILLED STEEL PIPE BOLLARDS MIN 3'-0" HIGH AND 3'-0" DEEP IN CONCRETE FOOTING (SURFACE MOUNTED WHEN IN PIT DECK).
  - HIGH SPEED ALBANY GARAGE DOOR. PROVIDE 5 GARAGE DOOR OPENERS. GARAGE DOOR TO BE OPENED BY BA (BARCODE AUTOMATION INC.) DUAL BEAM DECAL SCANNER. BA-440 OR APPROVED EQUAL. PROVIDE MIN 150 TOTAL STOCKERS THAT ARE BLACK ON BLACK. EXITING GARAGE TO BE CONTROLLED BY MOTION SENSOR.
  - CONCRETE COLUMNS TO HAVE SMOOTH ARCHITECTURAL FINISH WITH CHAMFERED CORNERS.
  - A VERTICAL CLEARANCE OF 126" AT HATCHED AREA AROUND LOADING BERTH (INDICATED WITH GRAY SHADING)
  - PROVIDE SIGNAGE PER BC 111 AND SECTION 502.7 OF ICC A117.1-09 FOR ACCESSIBLE PARKING A MINIMUM OF 60' ABOVE THE SURFACE OF PARKING. VAN ACCESSIBLE PARKING SHALL BE MARKED AS VAN ACCESSIBLE. SEE DETAIL 8/D1.01
  - CONDENSING UNIT ON WALL MOUNTED HANGAR.
  - CONCRETE FOUNDATION WALL WITH SMOOTH ARCHITECTURAL FINISH ABOVE GRADE. SEE STRUCTURAL DRAWINGS. REVEAL PER DETAIL 10/D1.02
  - STEEL STUD FRAMING WITH DENSGLASS SHEATHING AT ALL LEVEL 1 LOCATIONS. SEE STRUCTURAL FOR GAUGE AND SPACING.
  - SEE CIVIL AND LANDSCAPE DRAWINGS FOR CONTINUATION OF SIDEWALK. MAXIMUM 2% SLOPE AT EXTERIOR DOOR LANDINGS IN THE DIRECTION OF TRAVEL.
  - ELECTRICAL METER LOCATION. COORDINATE WITH ELECTRICAL DRAWINGS.
  - GAS METER LOCATION. COORDINATE WITH PLUMBING DRAWINGS.
  - VERIFY MAIL ROOM REQUIREMENTS WITH US POST OFFICE FOR EXACT CONFIGURATION AND NUMBER OF BOXES. SEE DETAIL 1/D1.02
  - COURTYARD FINISHED PER LANDSCAPE DRAWINGS.
  - PT DECK TO STEP IN COURTYARD. SEE DETAILS 6-B/D1.07 AND STRUCTURAL DRAWINGS.
  - PAINTED GYP BOARD WALL FINISH. PAINT COLOR AND BRAND TO BE OWNER SELECTED. SEE OWNERS SPEC AND INTERIOR DESIGN DRAWINGS.
  - EXTERIOR 2 HOUR RATED ASSEMBLY. SEE STRUCTURAL DRAWINGS. SEE DETAIL 2/P1.01
  - TENANT DEMISING WALLS. SEE SHEETS F103-F108. SEE DETAIL 5-B/P1.01
  - PRE-MANUFACTURED POWDER COATED STEEL DECK GUARDRAIL (42" HIGH) PER CODE (TYP). SEE DETAIL 3/D1.04
  - ALL WALLS SEPARATING CONDITIONED FROM UNCONDITIONED SPACE PROVIDE 1/2" AIR GAP BETWEEN FRAMING AND CONCRETE. INSULATE & MAINTAIN GAP. PROVIDE VAPOR BARRIER ON INTERIOR SIDE.
  - GACO FLUID APPLIED DECK MEMBRANE AT UNIT BALCONIES, PATIOS OVER PT DECK AND COURTYARD OVER PT DECK. INSTALL PER MANUFACTURER'S RECOMMENDATIONS. SEE DETAILS 12/D1.04.
  - UNIT BALCONIES AND PATIOS OVER PT DECK SLOPED MIN 1/4" PER FOOT FOR DRAINAGE. SEE PLUMBING DRAWINGS FOR LOCATIONS AND PIPING OF UNIT BALCONY DRAINS.
  - CRICKETS AS NECESSARY FOR PROPER ROOF DRAINAGE.
  - CLASS B SINGLE PLY ENERGY STAR COMPLIANT TPO ROOF MEMBRANE (60 ML WITH 20 YEAR WARRANTY) OVER SCHEDULED SHEATHING AND BOX TRUSSES. SLOPE TOWARDS ROOF DRAINS. SEE STRUCTURAL AND PLUMBING DRAWINGS AND DETAIL 1/P1.02. SEE DETAILS 3-4/D1.08 FOR PIPE PENETRATIONS.
  - ROOF DRAINS. PRIMARY ROOF DRAIN SHALL CONNECT TO STORM SEWER. SECONDARY DRAIN SHALL DAYLIGHT OUT THROUGH BUILDING WALL AT MAIN FLOOR LEVEL WITH STANDARD BRASS FITTING. SEE PLUMBING DRAWINGS. SEE DETAILS 12/D1.08
  - CONDENSING UNIT ON RUBBER PAD ON WOOD FRAMED PLATFORM. SLOPE PLATFORM FOR DRAINAGE ONTO ROOF. SEE MECHANICAL AND PLUMBING DRAWINGS. SEE STRUCTURAL DRAWINGS FOR FRAMING DETAIL.
  - RUBBER ROOFTOP TRAFFIC PAD SYSTEM INSTALLED PER MANUFACTURER'S RECOMMENDATIONS.
  - ROOF PARAPET. SEE PARAPET ROOF DETAILS 9-11/D1.01. SEE STRUCTURAL DRAWINGS FOR ASSOCIATED LATERAL BRACINGS AND DETAILS (TYP).
  - VERIFY HEIGHT OF ELEVATOR SHAFT OVERLUN WITH ELEVATOR MANUFACTURER.
  - SLOPE ELEVATOR AND STAR TOWER ROOFS TO DRAIN TO GUTTER AND DOWNSPOUT ONTO SPLASH BLOCK AT LOWER ROOF.
  - MECHANICAL SHAFT ROOF PENETRATION. SEE DETAIL 3/D1.08
  - MECHANICAL SHAFT ROOF OVERBUILD.
  - 6'-0" TALL DECORATIVE FENCE SEE DETAIL 9/D1.02

- GENERAL NOTES:**
- ALL BATHROOMS SHALL BE ADAPTABLE. GENERAL CONTRACTOR SHALL VERIFY THAT ALL FIXTURE LOCATIONS, SOLID BLOCKING AND CLEAR FLOOR SPACES SHALL MEET THE MINIMUM REQUIREMENTS OF THE 2015 BC, ANSI 117-1.03 AND THE REQUIREMENTS OF SPECIFICATION A BATHROOM OF THE FAIR HOUSING ACT DESIGN MANUAL.
  - ALL ENTRANCES TO UNITS SHALL BE ON AN ACCESSIBLE ROUTE AND PROVIDE DISABLED ACCESS TO THE UNITS. FLOOR LEVEL OUTSIDE DOORWAYS SHALL BE NO MORE THAN 1/2" BELOW INSIDE FLOOR LEVEL AND SHALL NOT SLOPE MORE THAN 1/8" PER FOOT.
  - ALL ENTRY DOORS SHALL BE 36" WIDE, HAVE LEVER TYPE LATCHES AND HAVE THRESHOLDS NO HIGHER THAN 1/2" WHICH ARE BEVELLED WITH A SLOPE NO GREATER THAN 1/2". SEE DETAIL 3/D1.01
  - CLEAR WIDTH OF AN ACCESSIBLE ROUTE SHALL BE 36" MINIMUM, EXCEPT AT DOORS. CLEAR WIDTH OF THE ACCESSIBLE ROUTE WITH TURNS AROUND AN OBSTRUCTION LESS THAN 48" WIDE SHALL HAVE A CLEAR SPACE OF 42" x 48".
  - ELECTRICAL SWITCHES, OUTLETS, THERMOSTATS AND OTHER ENVIRONMENTAL CONTROLS SHALL HAVE NO OPERABLE PARTS WHICH ARE HIGHER THAN 48" NOR LESS THAN 15" A.F.F.
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  - PROVIDE SOLID 2X RE BLOCKING AT ALL CEILING AND FLOOR LEVELS, TOPS AND BOTTOMS OF STAIRWAYS, AND AT DROPPED CEILING LOCATIONS.

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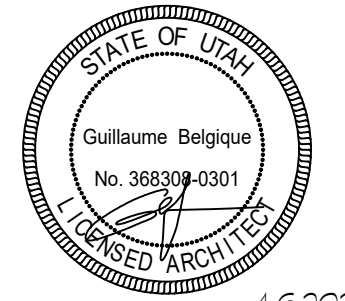
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 Guillaume Belgique  
 No. 368309-0301  
 LICENSED ARCHITECT  
 4.6.2020

**CENTRAL WEST**  
 579 WEST 200 SOUTH  
 SALT LAKE CITY, UT

**Date**  
 DATE REVISIONS

**Sheet Title**  
 Overall Floor Plan Level 6

**Sheet Number**  
 A1.07




**BUILDING ELEVATION KEYED NOTES:**

- 1 SLOPE EXTERIOR FINISH GRADE AWAY FROM PERIMETER OF BUILDING FOR PROPER DRAINAGE (TYP)
- 2 STEPPED FOOTINGS AND FOUNDATION WALLS AS REQUIRED
- 3 SCHEDULED DOOR. SEE DOOR SCHEDULE, TYPES, AND STYLES ON SHEET A6.01. PROVIDE AND INSTALL ALL REQUIRED DOOR FLASHING PER MANUFACTURERS RECOMMENDATIONS.
- 4 SCHEDULED WINDOW. SEE WINDOW SCHEDULE, TYPES, AND STYLES ON SHEET A6.02. PROVIDE AND INSTALL ALL REQUIRED WINDOW FLASHING PER MANUFACTURERS RECOMMENDATIONS.
- 5 COLORED AND SIZED ALUMINUM STOREFRONT. SEE DOOR AND WINDOW SCHEDULE A6.01+A6.02. PROVIDE COLOR SAMPLES FOR APPROVAL.
- 6 PRE-MANUFACTURED POWDER COATED STEEL DECK GUARDRAIL (42" HIGH) PER CODE (TYP). SEE DETAILS 1-3/01.04
- 7 VENTED ALUMINUM SOFFIT AND RIBBED FASCIA AT BALCONIES SEE DETAIL 2/01.04. PROVIDE CONTINUOUS PIECE FOR BALCONY FASCIA.
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- 12 BUILDING SIGNAGE TO BE INSTALLED BY LICENSED CONTRACTOR UNDER SEPARATE PERMIT. VERIFY SIGNAGE BUDGET AND DESIGN WITH OWNER.
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- 18 RUNNING BOND KING BRICK. SEE DETAIL SHEETS FOR SPECIFIC APPLICATION.
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- 20 12" MC CORRUGATED METAL SIDING (26 GAUGE WITH KYNAR FINISH) INSTALL PER MANUFACTURERS RECOMMENDATIONS. SEE DETAIL SHEETS FOR SPECIFIC APPLICATION.
- 21 8" CONCRETE STEM WALL.
- 22 APPROXIMATE LOCATION OF EXISTING WINDOWS FROM NEIGHBORING PROPERTY. FIELD VERIFY.
- 23 WALL MURAL AREA. ART PIECE TBD BY OWNER.



1 BUILDING ELEVATION SOUTH  
A2.01 SCALE: 1/8" = 1'-0"  
(24' x 36')

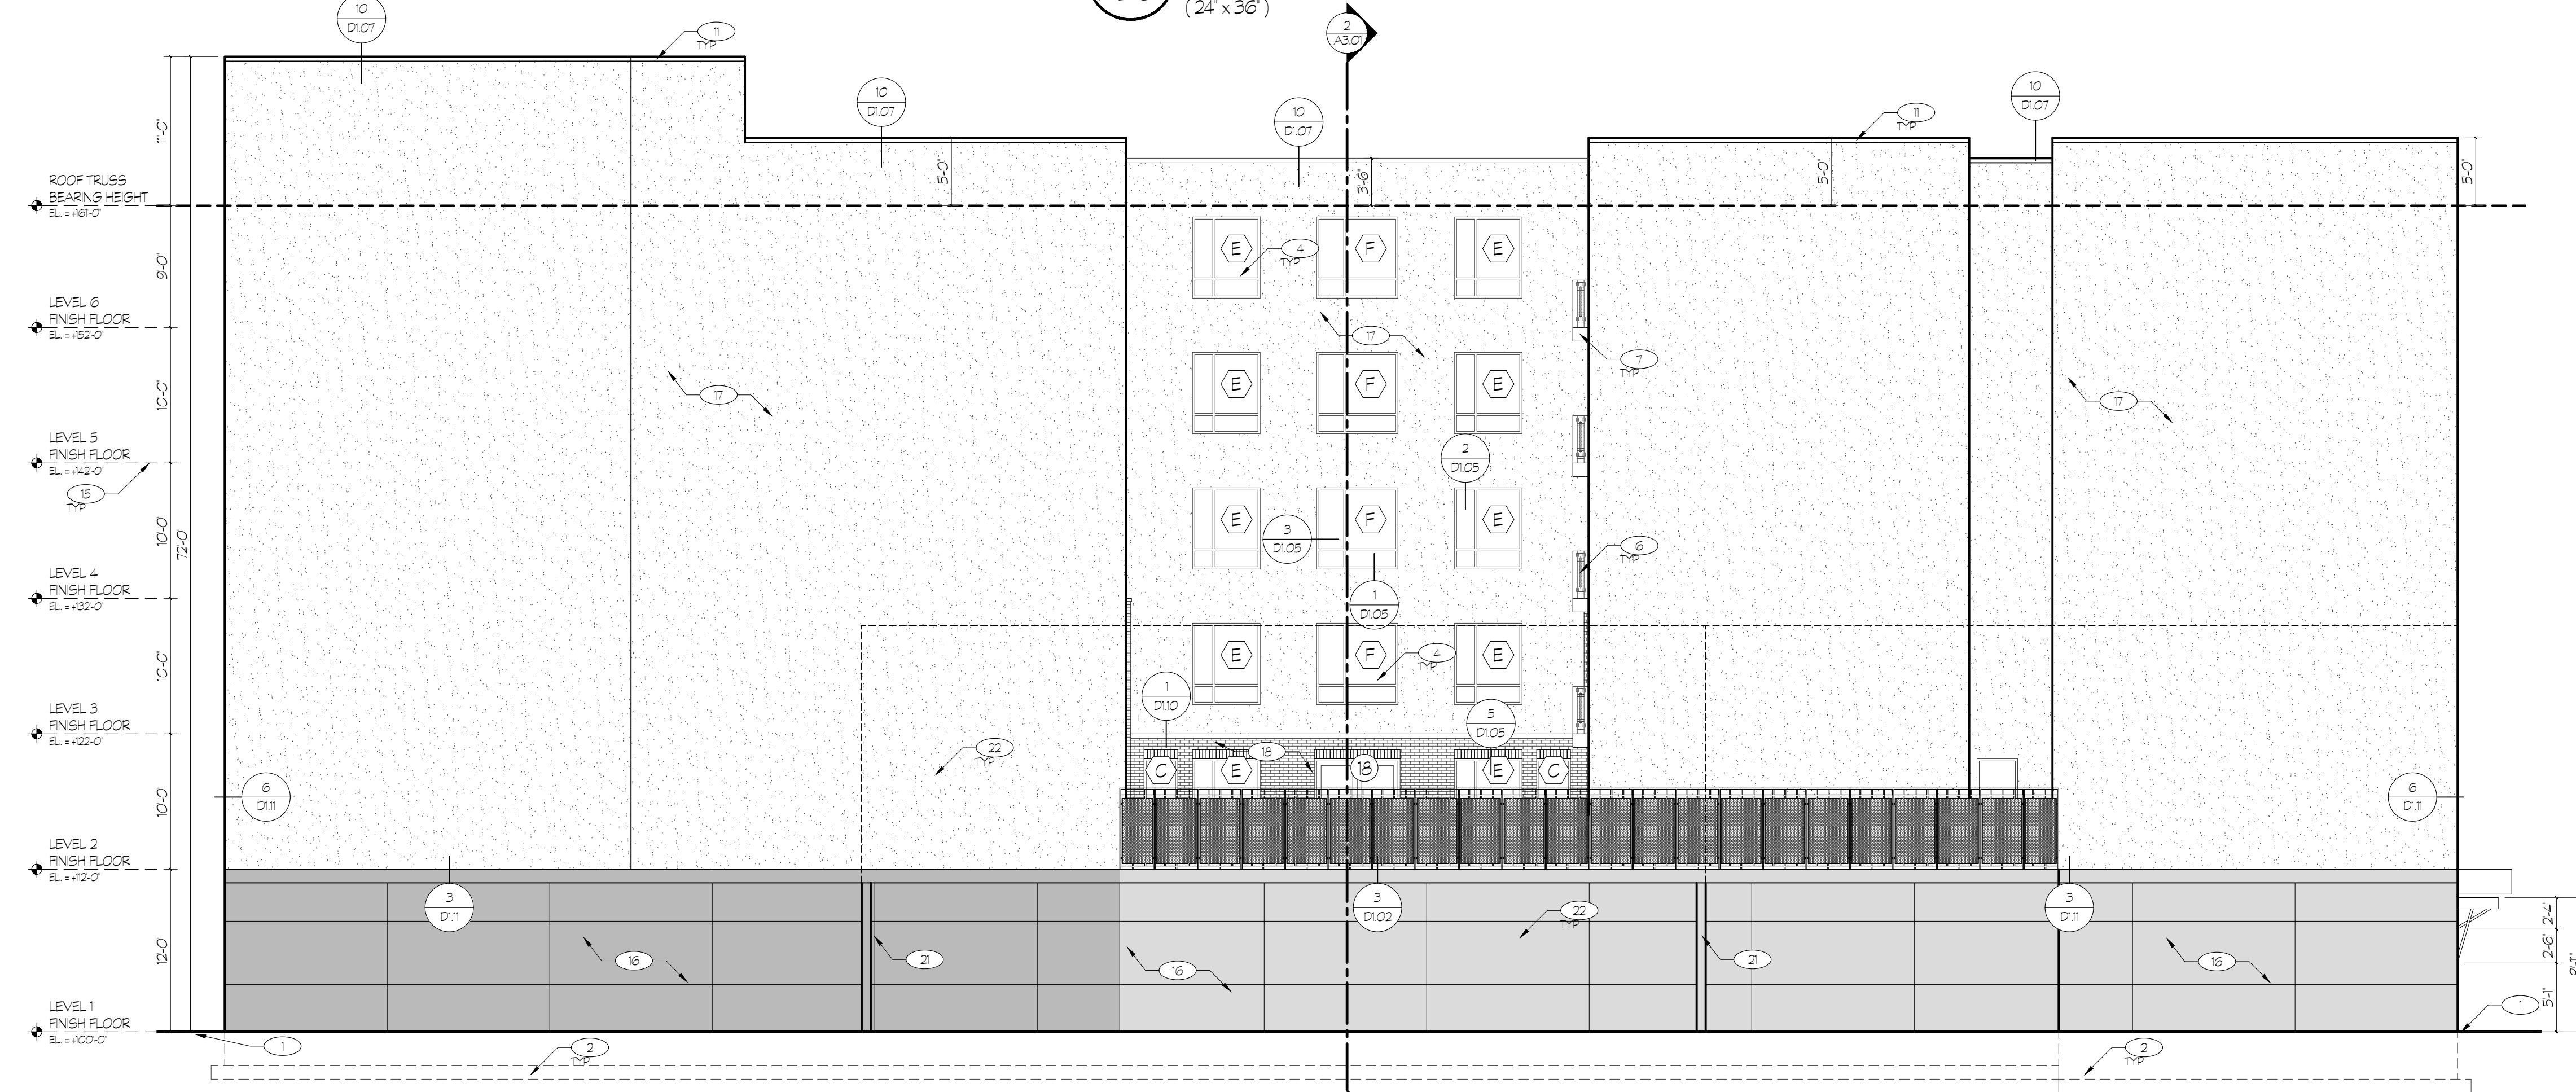

2 BUILDING ELEVATION EAST  
A2.01 SCALE: 1/8" = 1'-0"  
(24' x 36')

West Elevation				
Overall	Overall Minus Glass	First Floor only	Square Footage	Percentage
Total Façade			10,968 SQFT	100%
Glazing			472 SQFT	4.3%
Remaining Façade			10,496 SQFT	100%
Durable*			4,756 SQFT	45.4%
Metal			0 SQFT	0%
Stucco			5,741 SQFT	54.6%
First Floor overall			1,886 SQFT	100%
Glazing			0 SQFT	0%

North Elevation				
Overall	Overall Minus Glass	First Floor only	Square Footage	Percentage
Total Façade			7,266 SQFT	100%
Glazing			2,516 SQFT	35%
Remaining Façade			4,750 SQFT	100%
Durable*			2,881 SQFT	28%
Metal			469 SQFT	10%
Stucco			1,400 SQFT	62%
First Floor overall			1,247 SQFT	100%
Glazing			692 SQFT	55%

**CENTRAL WEST**  
579 WEST 200 SOUTH  
SALT LAKE CITY, UT

Date

DATE	REVISIONS


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South and East Building Elevations

Sheet Number


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**BUILDING ELEVATION KEYED NOTES:**

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**1 BUILDING ELEVATION NORTH**  
A2.02 SCALE: 1/8" = 1'-0"  
(24' x 36')

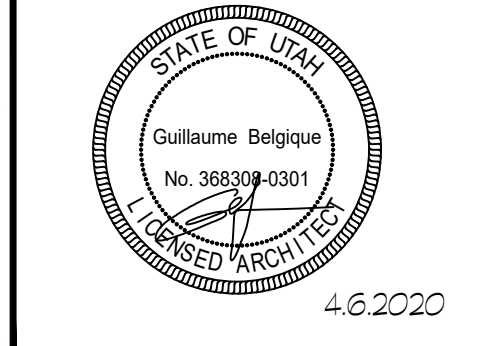

**2 BUILDING ELEVATION WEST**  
A2.02 SCALE: 1/8" = 1'-0"  
(24' x 36')

South Elevation				
Overall	Overall Minus Glass	First Floor only	Square Footage	Percentage
Total Façade			7,335 SQFT	100%
Glazing			1,719 SQFT	23.4%
Remaining Façade			5,616 SQFT	100%
Durable*			1,888 SQFT	33.7%
Metal			250 SQFT	4.4%
Stucco			3,728 SQFT	66.3%
First Floor overall			1,262 SQFT	100%
Glazing			0 SQFT	0%

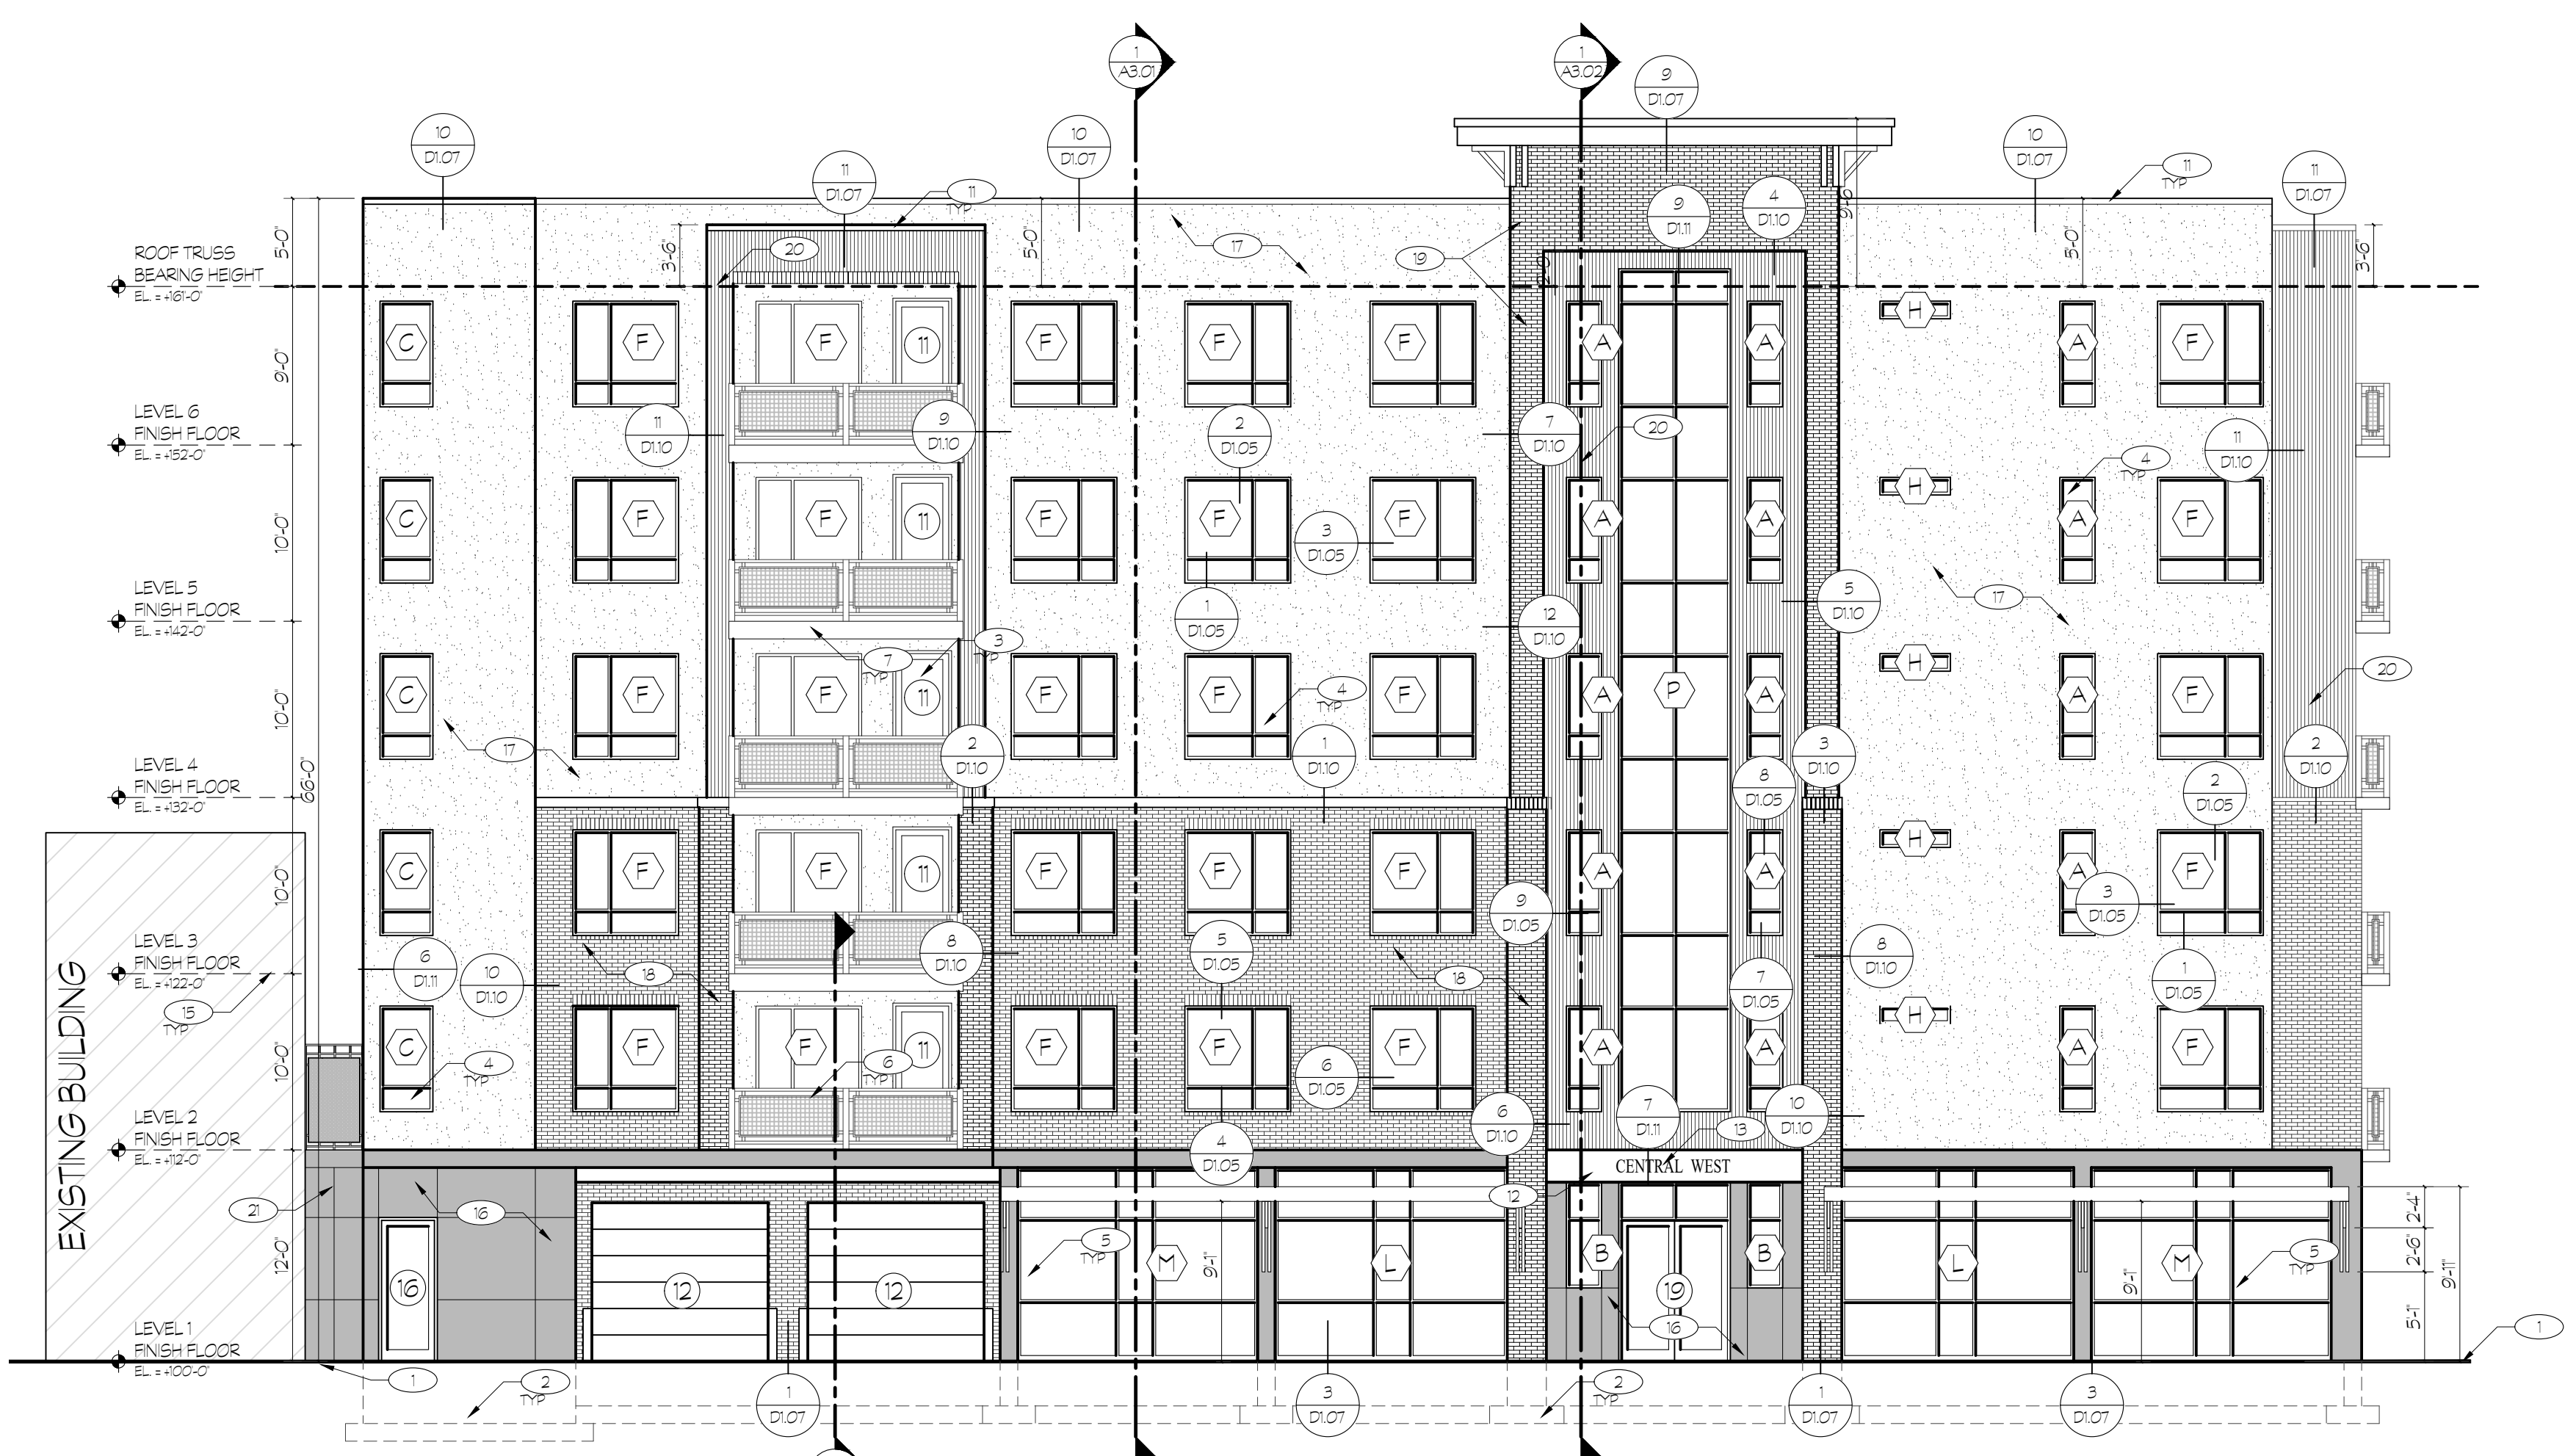East Elevation				
Overall	Overall Minus Glass	First Floor only	Square Footage	Percentage
Total Façade			10,569 SQFT	100%
Glazing			2,597 SQFT	24.5%
Remaining Façade			7,972 SQFT	100%
Durable*			3,873 SQFT	48.6%
Metal			1,281 SQFT	16%
Stucco			4,099 SQFT	51.4%
First Floor overall			1,833 SQFT	100%
Glazing			354 SQFT	19.3%

**CENTRAL WEST**  
579 WEST 200 SOUTH  
SALT LAKE CITY, UT

**Date**

DATE REVISIONS


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North and West Building Elevations

**Sheet Number**

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**CENTRAL WEST**  
579 WEST 200 SOUTH  
SALT LAKE CITY, UT

Date

DATE	REVISIONS

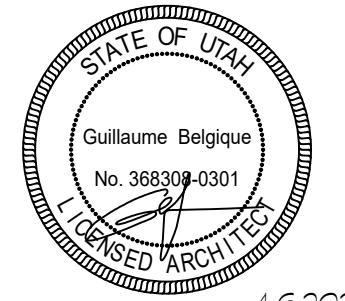
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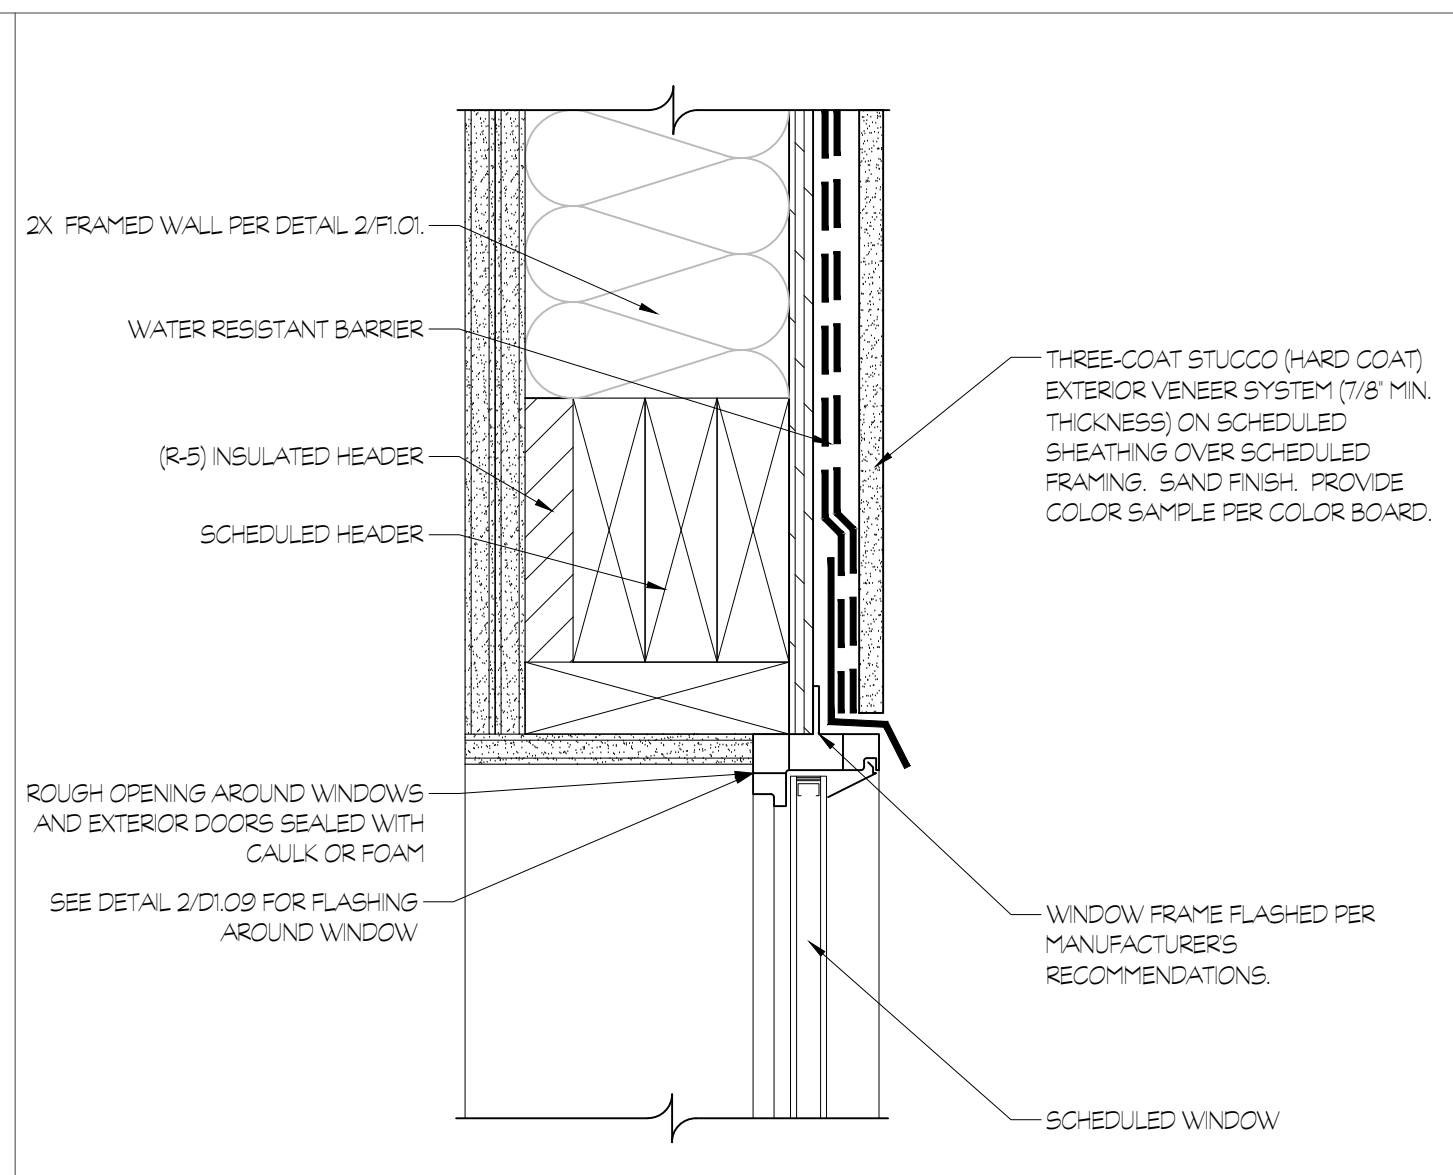
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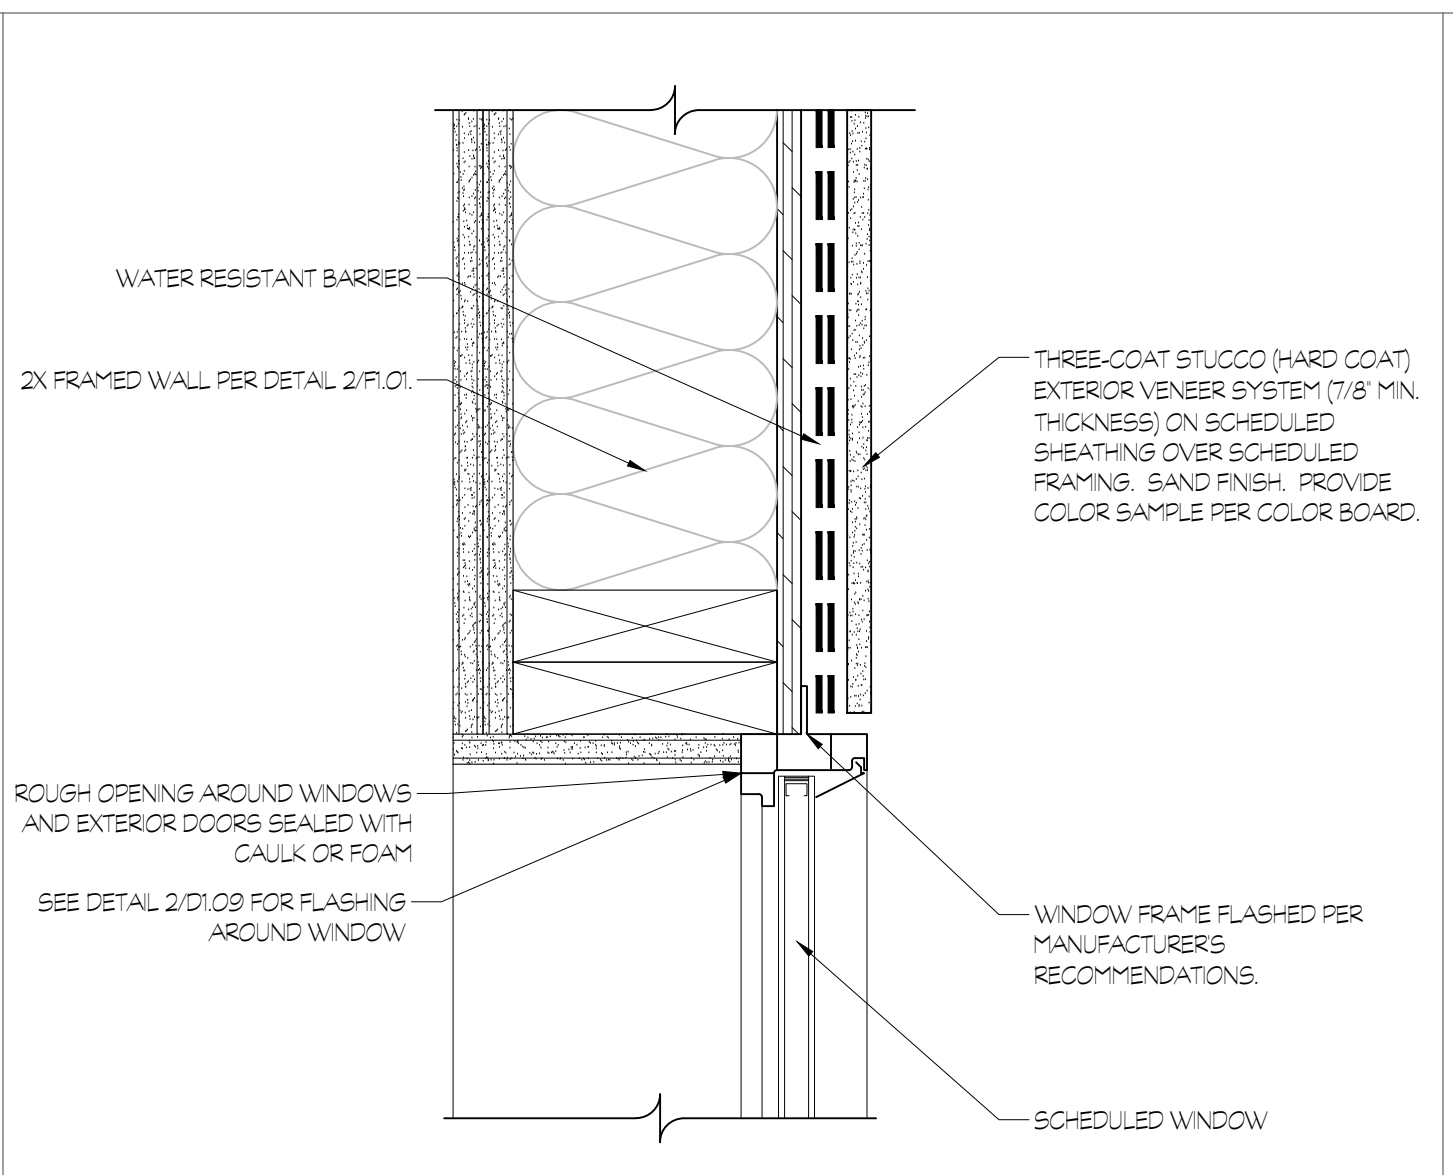
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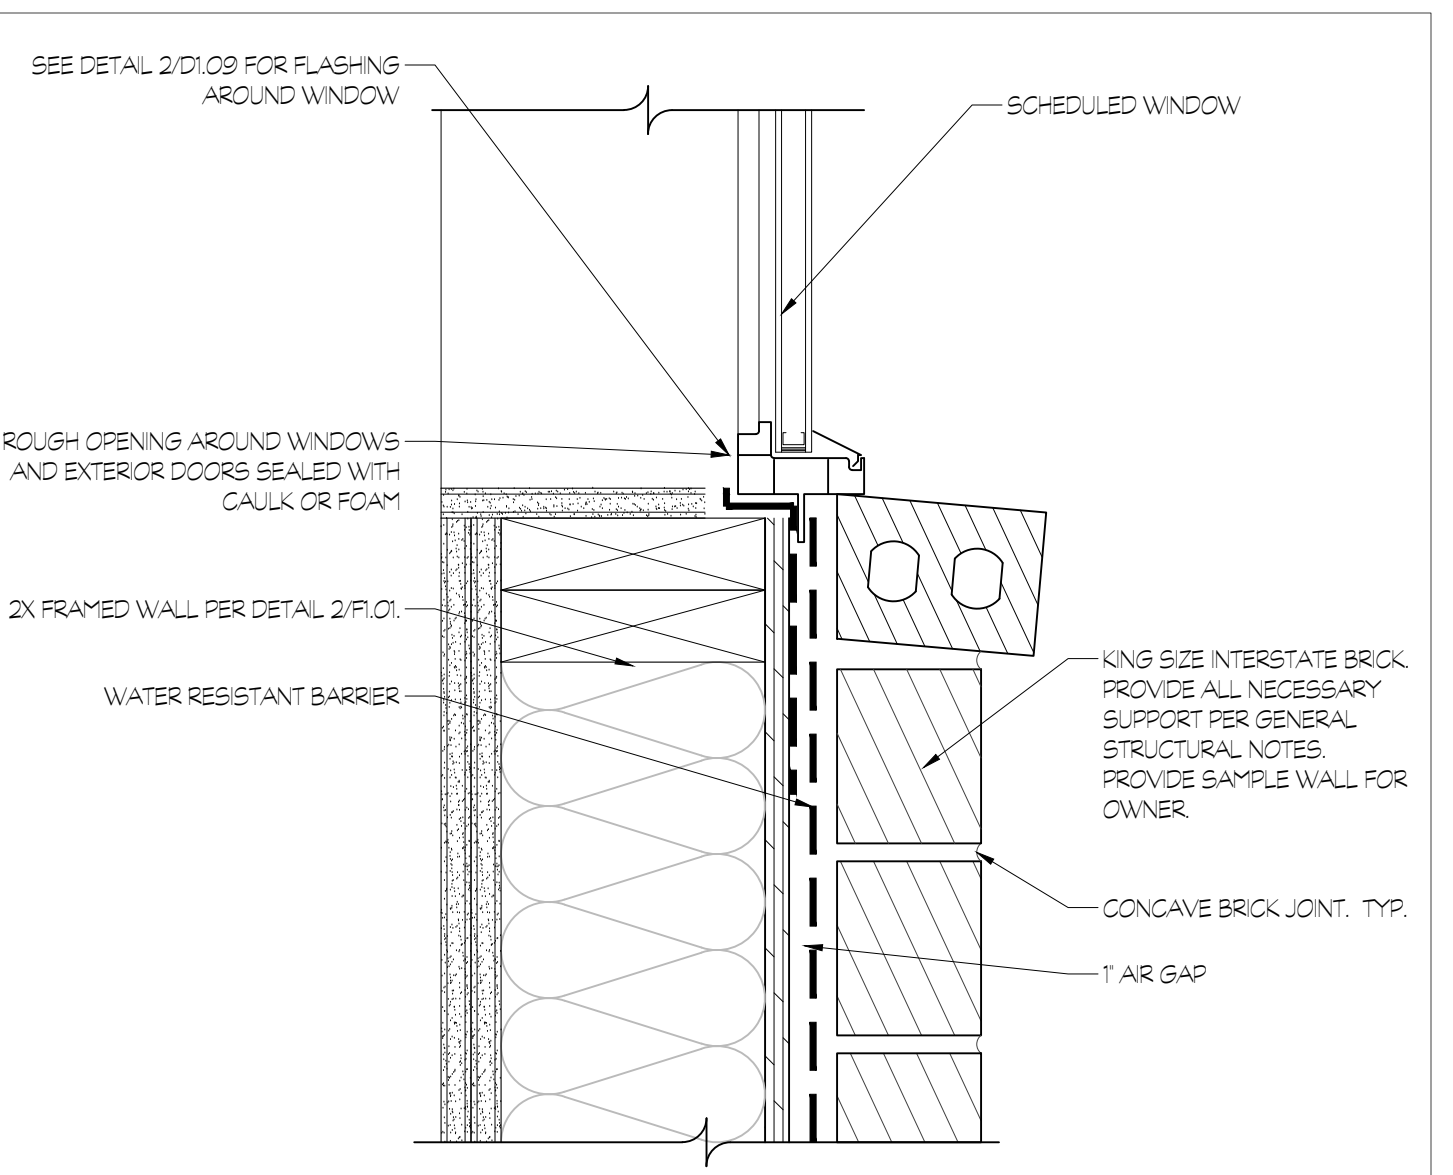
**1 WINDOW SILL**  
D1.05 SCALE : 3" = 1'-0"  
STUCCO




**2 WINDOW HEAD**  
D1.05 SCALE : 3" = 1'-0"  
STUCCO




**3 WINDOW JAMB**  
D1.05 SCALE : 3" = 1'-0"  
STUCCO

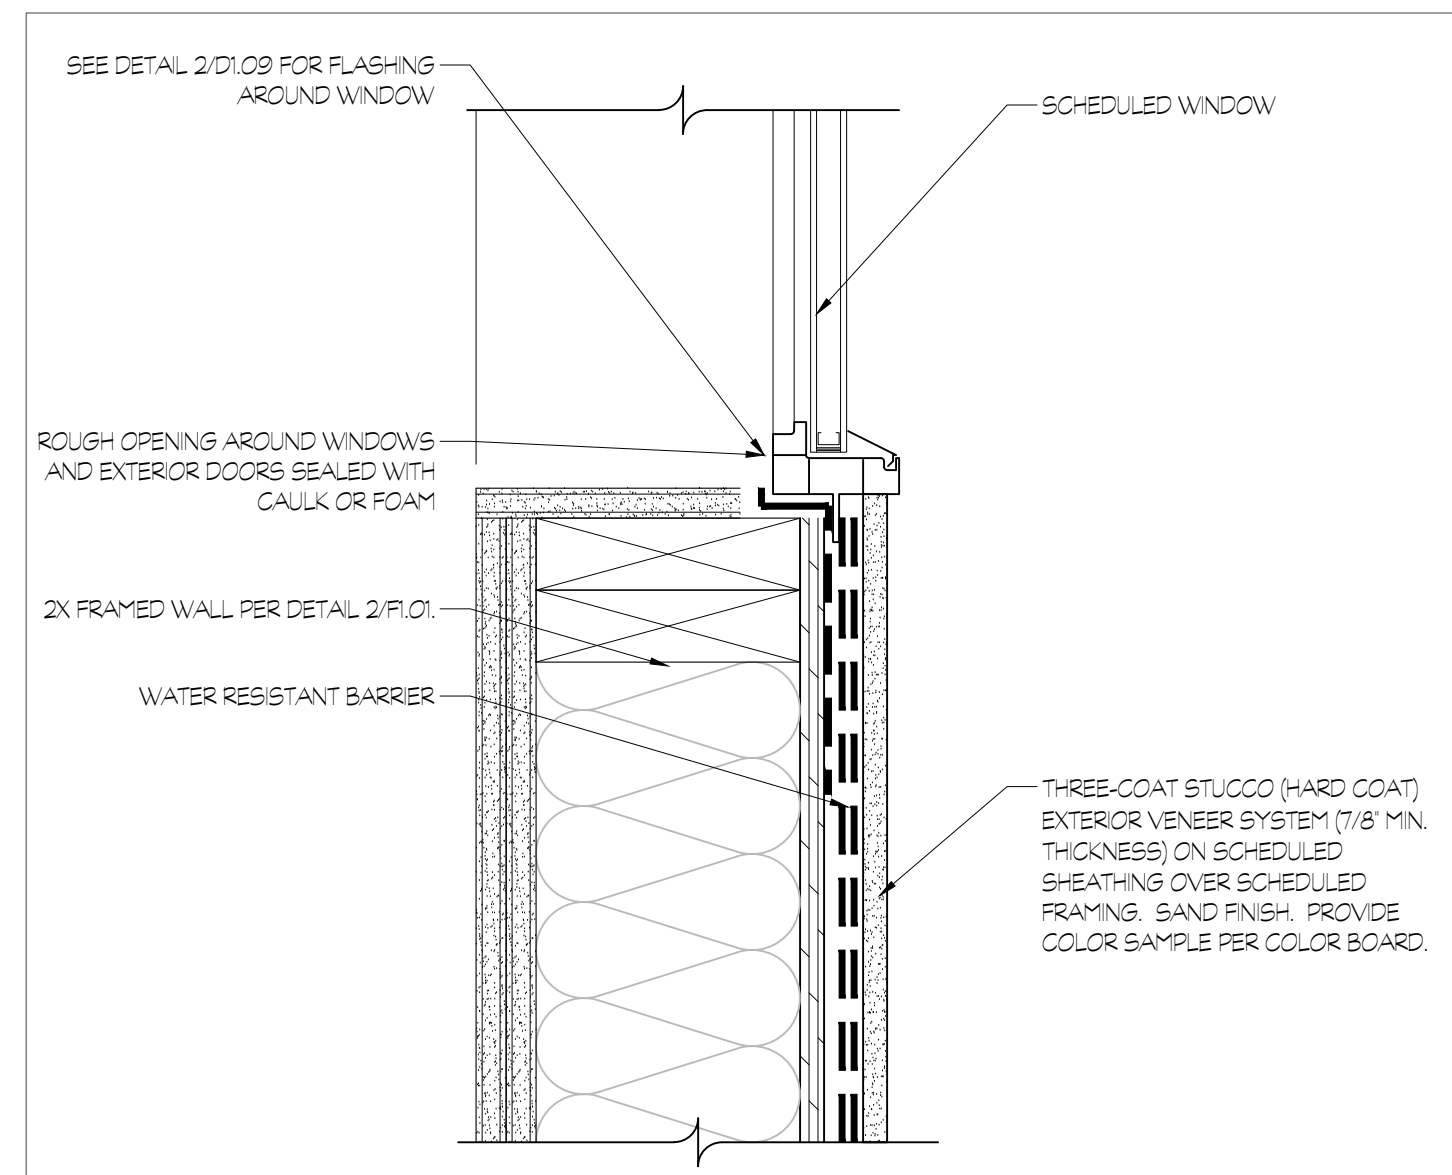


**4 WINDOW SILL**  
D1.05 SCALE : 3" = 1'-0"  
BRICK

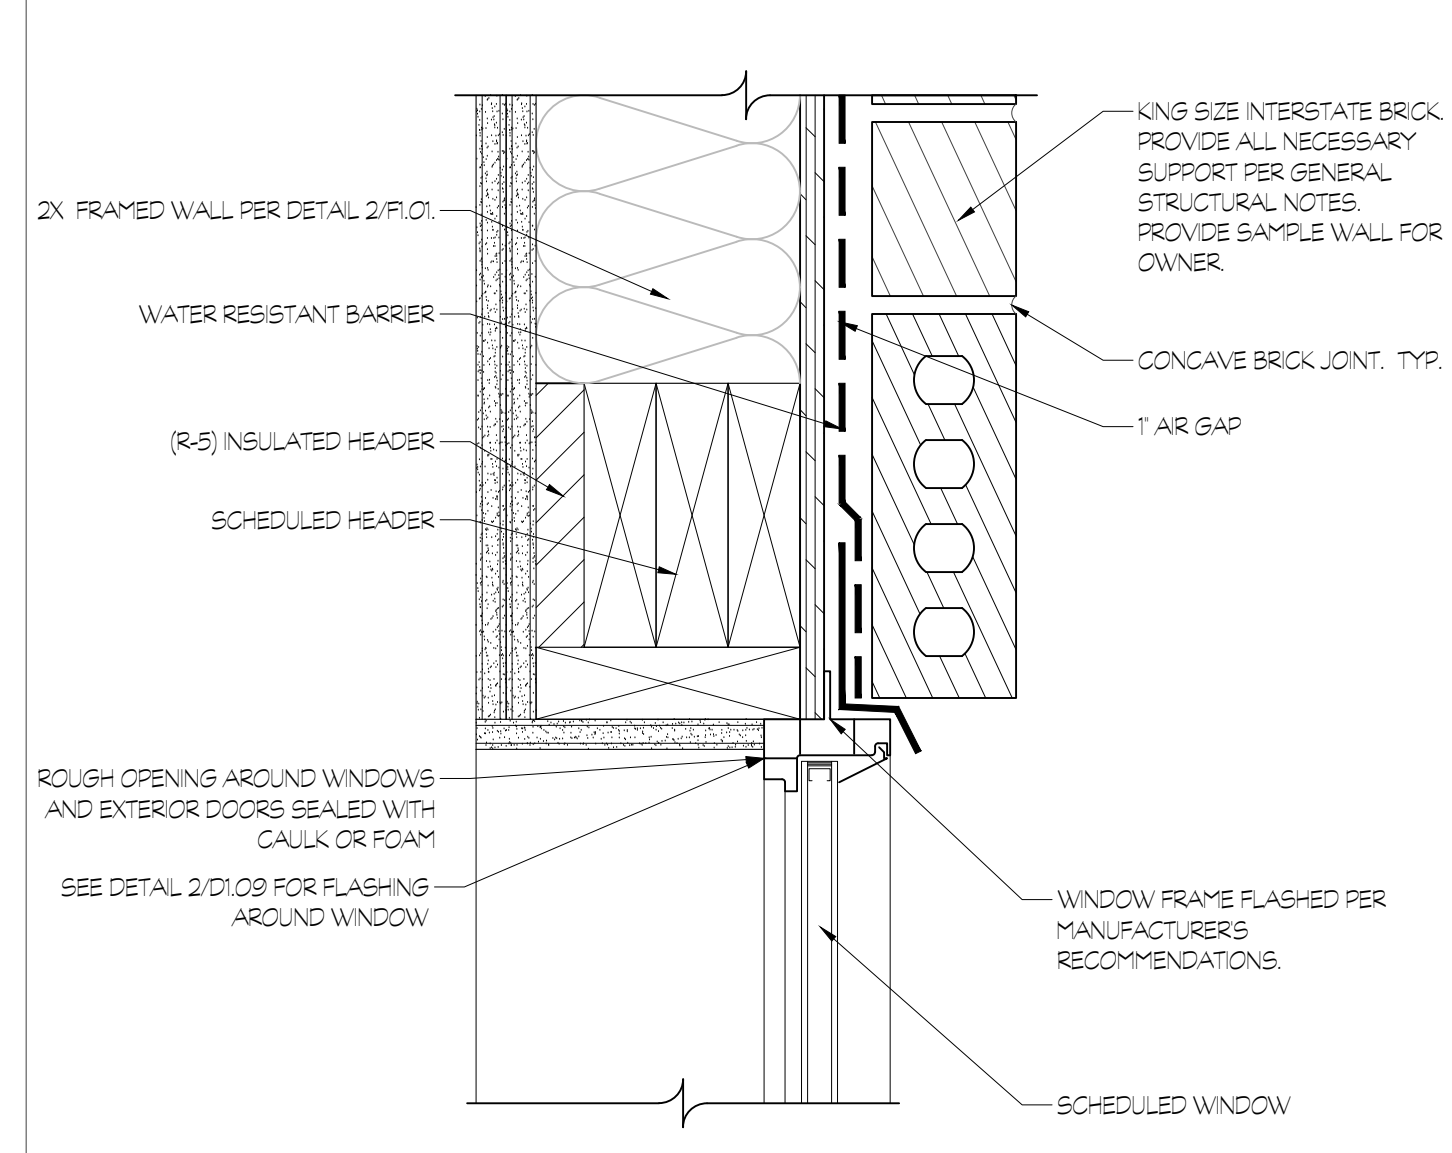


**5 WINDOW HEAD**  
D1.05 SCALE : 3" = 1'-0"  
BRICK

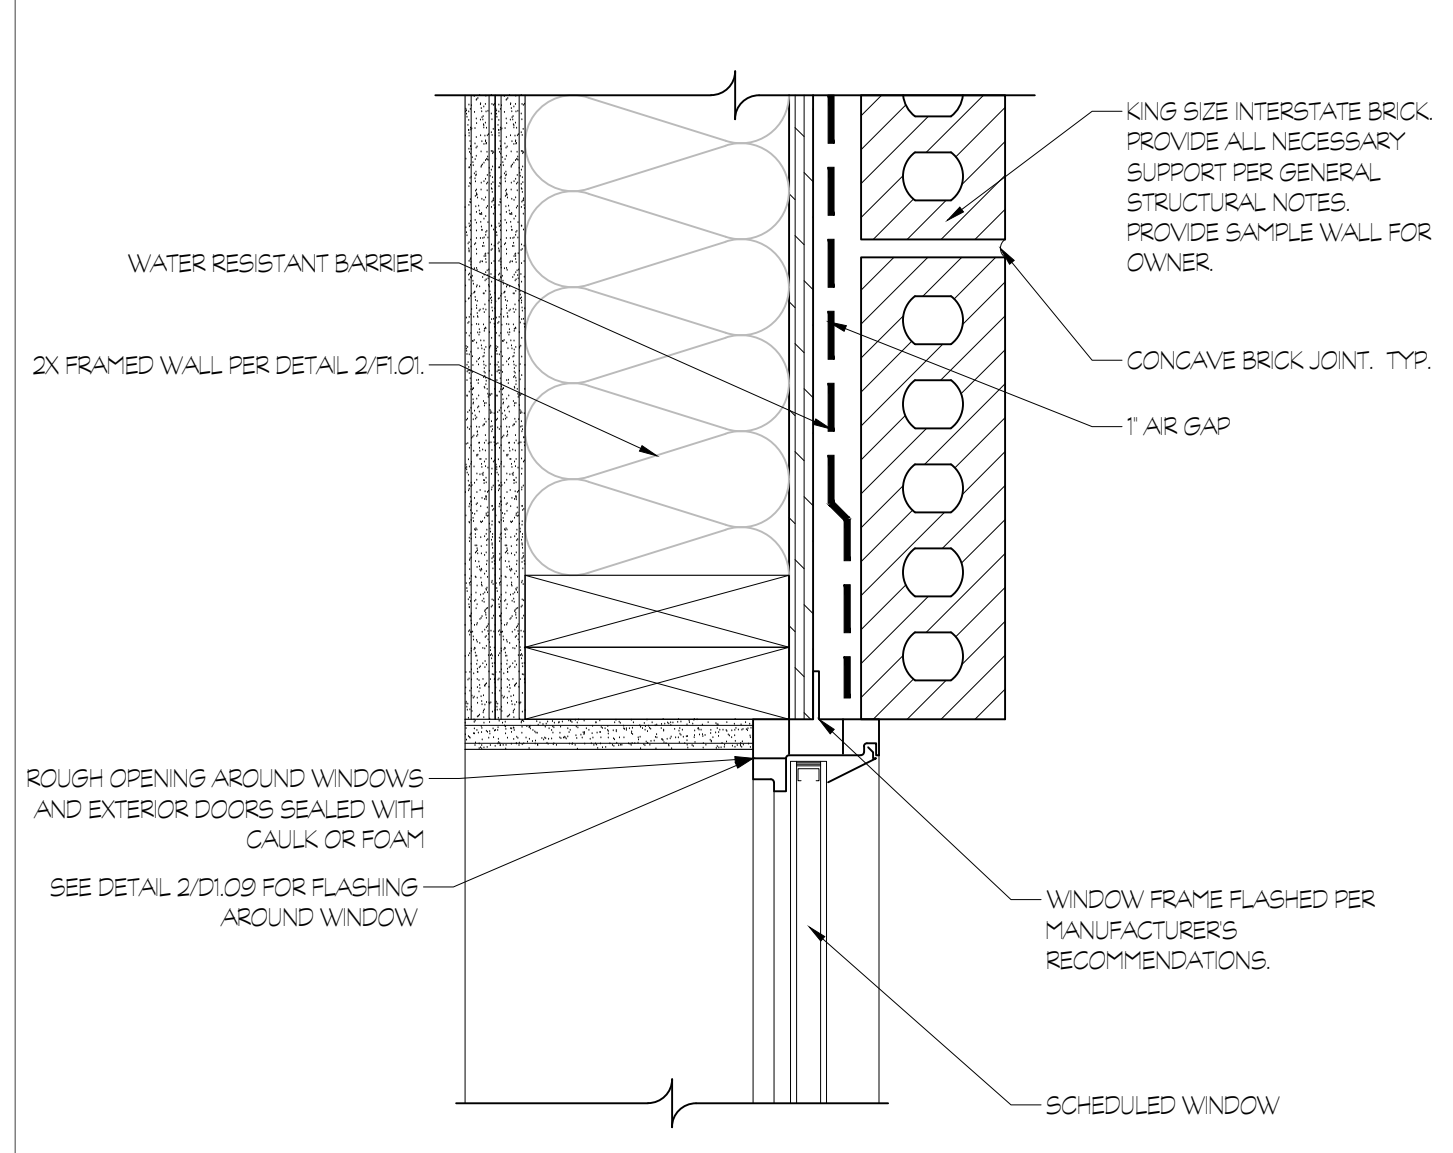


**6 WINDOW JAMB**  
D1.05 SCALE : 3" = 1'-0"  
BRICK

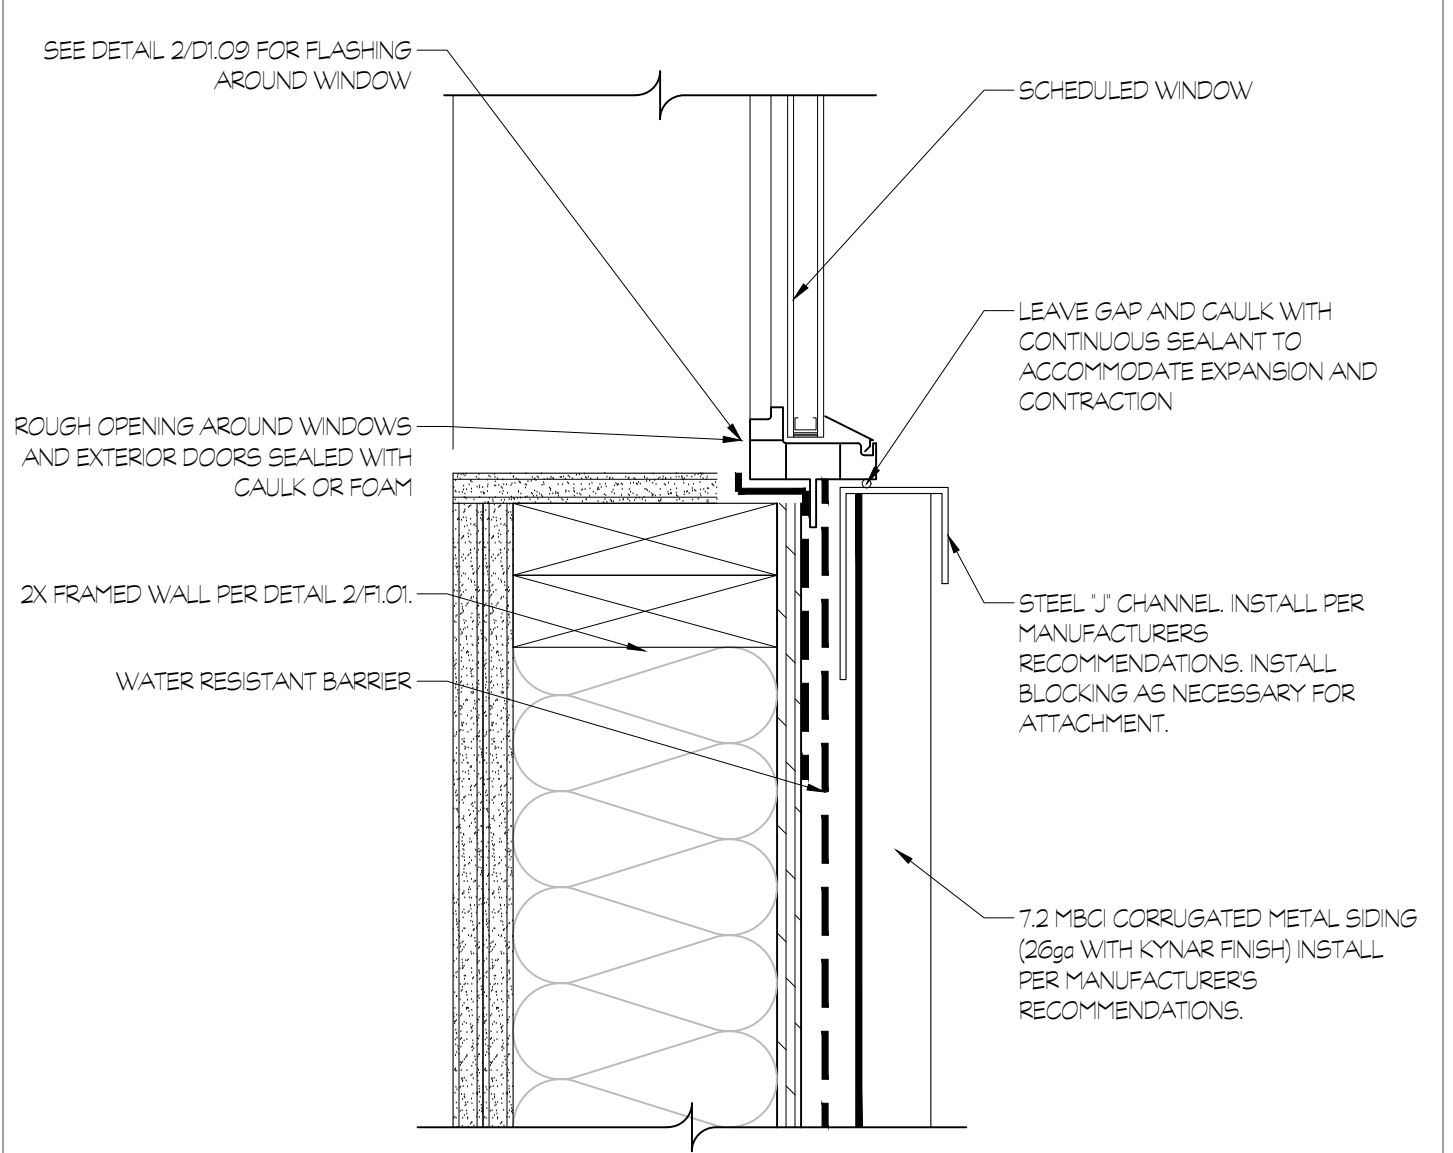


**7 WINDOW SILL**  
D1.05 SCALE : 3" = 1'-0"  
CORRUGATED METAL

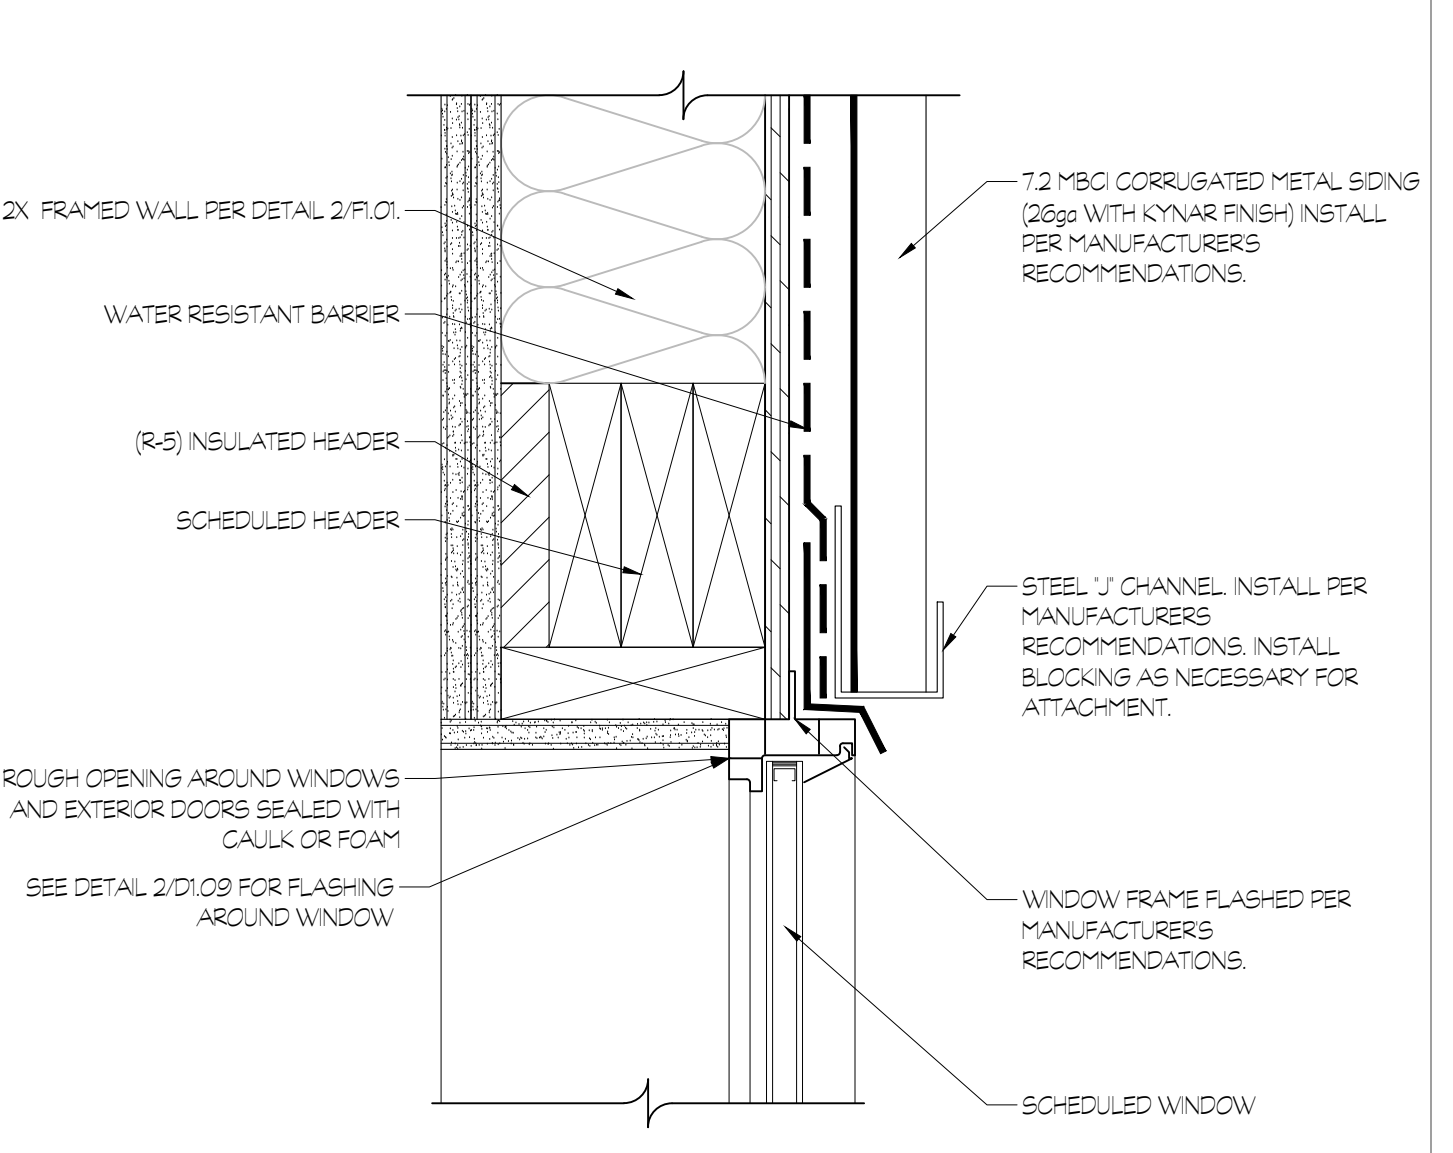


**8 WINDOW HEAD**  
D1.05 SCALE : 3" = 1'-0"  
CORRUGATED METAL

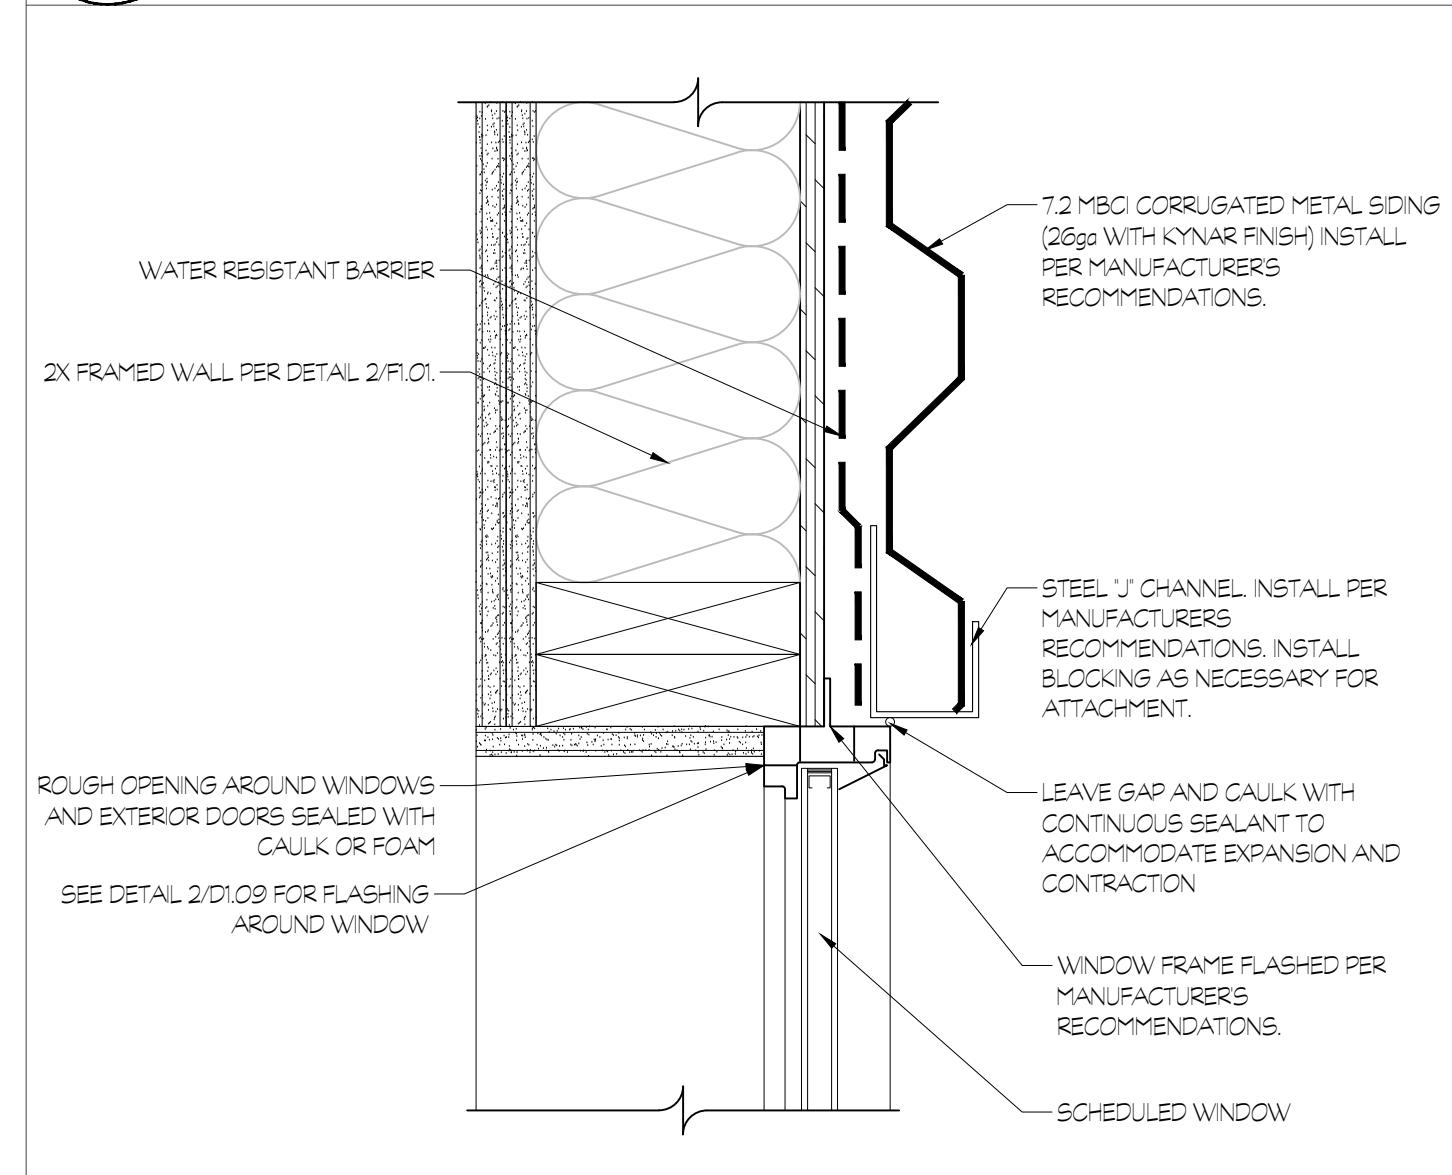


**9 WINDOW JAMB**  
D1.05 SCALE : 3" = 1'-0"  
CORRUGATED METAL

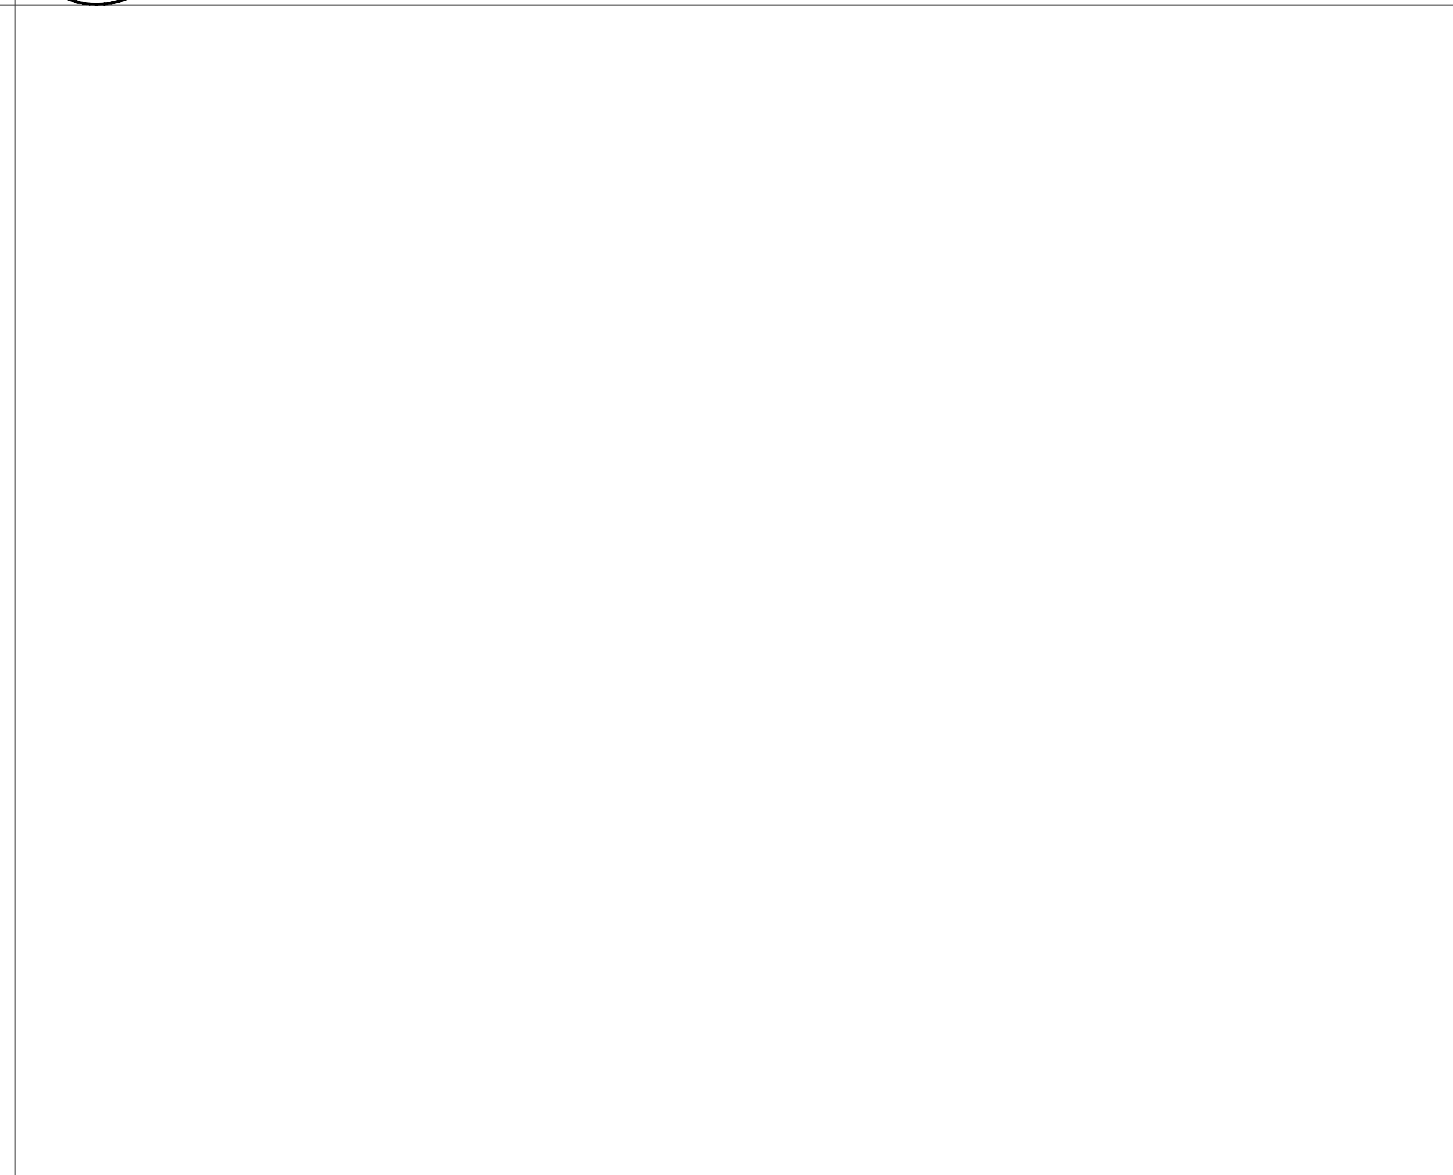

**10 NOT USED**  
D1.05 SCALE : 3" = 1'-0"

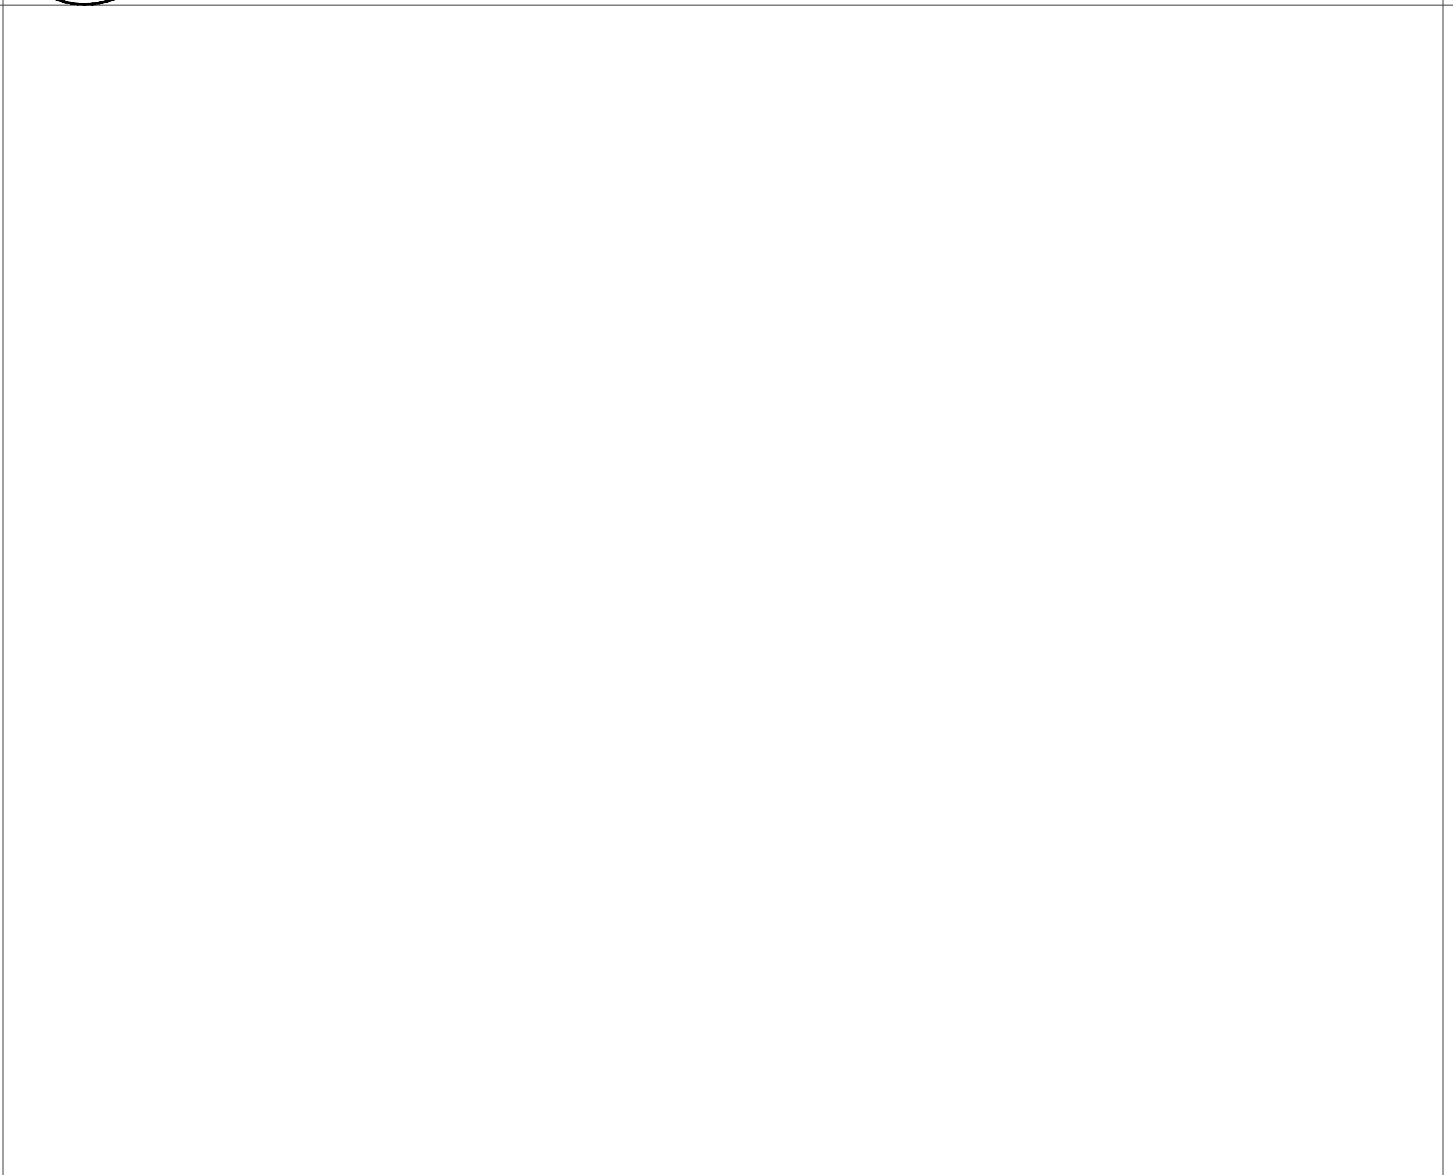

**11 NOT USED**  
D1.05 SCALE : 3" = 1'-0"

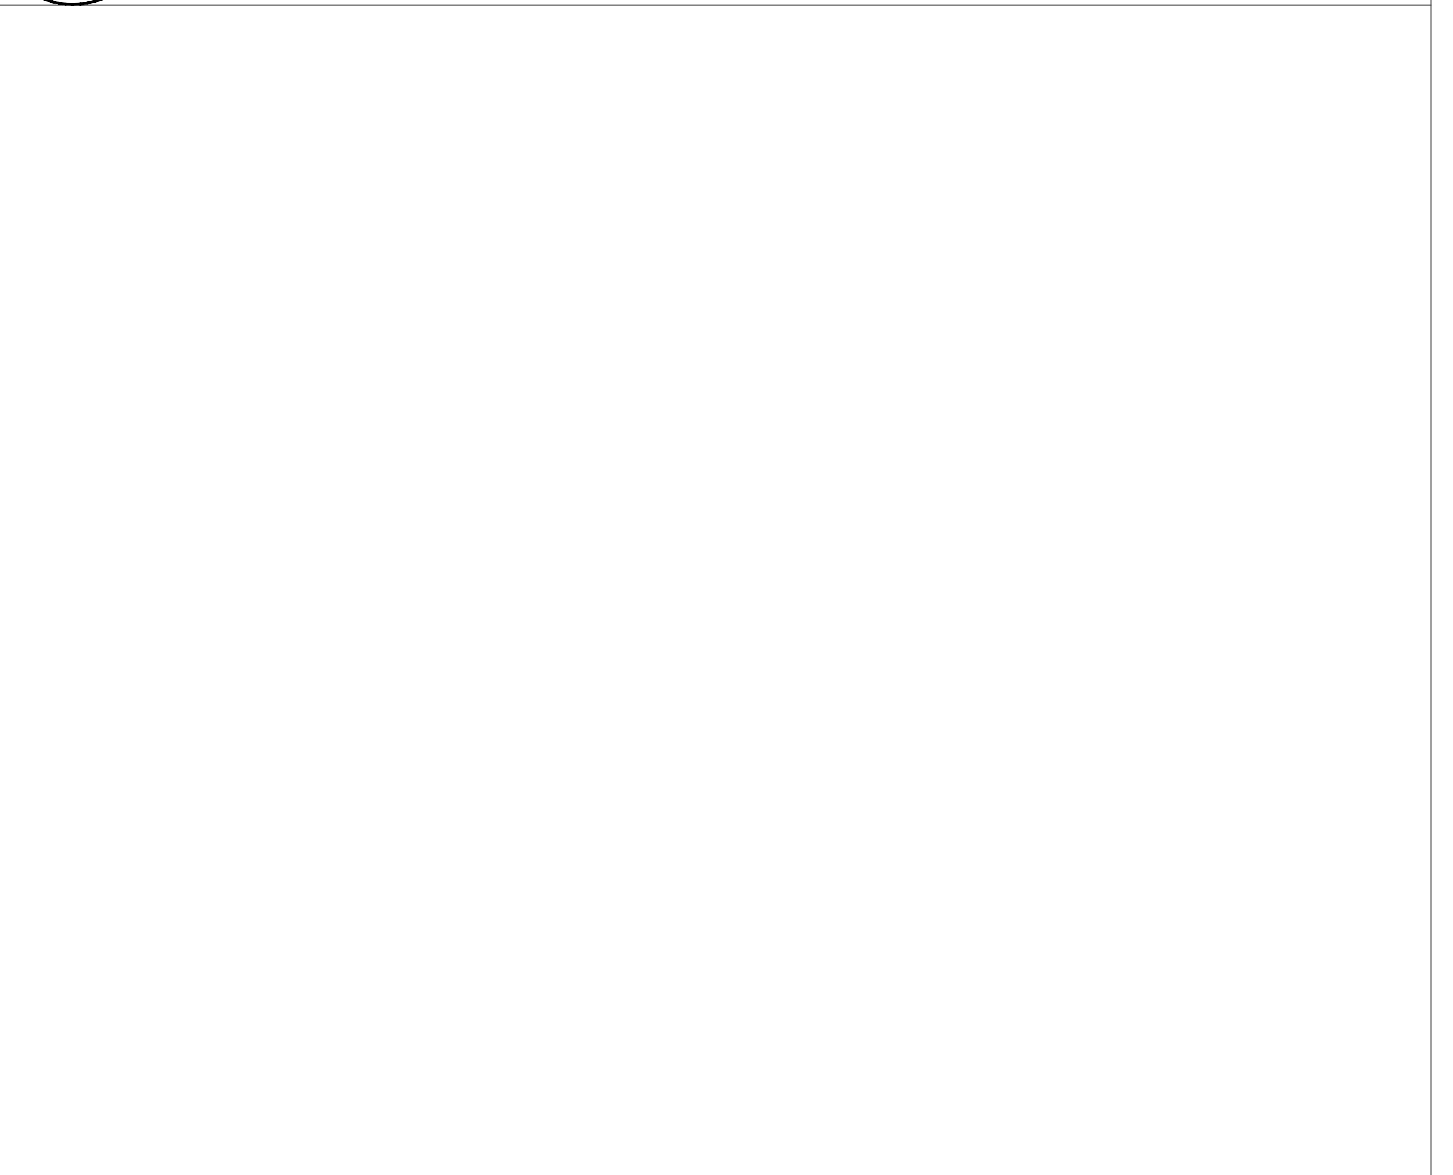

**12 NOT USED**  
D1.05 SCALE : 3" = 1'-0"